



Office of General Services

DESIGN & CONSTRUCTION GROUP
THE GOVERNOR NELSON A. ROCKEFELLER
EMPIRE STATE PLAZA
ALBANY, NY 12242

ADDENDUM NO. 6 TO PROJECT NO. 46218

CONSTRUCTION, HVAC, PLUMBING AND ELECTRICAL WORK
PROVIDE IMAGING BAY, BUILDING 35
NATHAN KLINE RESEARCH INSTITUTE
140 OLD ORANGEBURG RD
ORANGEBURG, NY

December 1, 2025

NOTE: This Addendum forms a part of the Contract Documents. Insert it in the Project Manual. Acknowledge receipt of this Addendum in the space provided on the Bid Form.

CHANGES TO ADDENDUM NO.4

1. Item No. 4: Revised Drawings:
 - a. Drawing Nos. E-202: Add the drawing scale 1/16" = 1'-0" for the ELECTRICAL SITE PLAN - LIGHTING.

GENERAL REQUIREMENTS – COMMON DOCUMENTS

2. Page 012100 – 1, Subparagraph 1.04 (A): Change “230923” to read “230924”

CONSTRUCTION WORK DRAWINGS

3. Revised Drawings:
 - a. Drawings No. A-502, A-504, noted “12/1/2025 ADDENDUM #6” accompanies this Addendum and supersedes the same numbered originally issued drawings.

END OF ADDENDUM

Brady Sherlock, P.E.
Director, Division of Design
Design & Construction

CONSULTANTS:

CERTIFICATE OF AUTHORIZATION #:



EXPIRATION DATE: 06/30/2027
 ARCHITECT:
 JACK L. GORDON ARCHITECTS
 MEP/FP/FA/ENGINEER:
 LEGACY ENGINEERS
 SITE/CIVIL ENGINEER:
 HAYDUK ENGINEERING
 GEOTECHNICAL ENGINEER:
 HARTLAND ENGINEERING
 STRUCTURAL ENGINEER:
 YSRAEL A. SEINUK, PC
 IT CONSULTANT:
 CERAMI & ASSOCIATES

ENERGY CODE STATEMENT
 TO THE BEST OF THE ARCHITECT/ENGINEER'S KNOWLEDGE, BELIEF AND PROFESSIONAL JUDGEMENT, THESE PLANS AND/OR SPECIFICATIONS ARE IN COMPLIANCE WITH THE 2020 NEW YORK STATE ENERGY CODE.
 2020 NEW YORK STATE FIRE CODE AND BUILDING CODE
 1. TO THE BEST OF THE KNOWLEDGE, BELIEF AND PROFESSIONAL JUDGEMENT OF THE LICENSED PROFESSIONAL SEALING THESE PLANS AND SPECIFICATIONS, THESE PLANS ARE IN COMPLIANCE WITH THE 2020 NEW YORK STATE FIRE CODE AND BUILDING CODE.

WARNING:
 THE ALTERATION OF THIS MATERIAL IN ANY WAY, UNLESS DONE UNDER THE DIRECTION OF A COMPARABLE PROFESSIONAL, I.E. ARCHITECT FOR AN ARCHITECT, ENGINEER FOR AN ENGINEER OR LANDSCAPE ARCHITECT FOR A LANDSCAPE ARCHITECT, IS A VIOLATION OF THE NEW YORK STATE EDUCATION LAW AND/OR REGULATIONS AND IS A CLASS "A" MISDEMEANOR.

REGISTRATION EXPIRES:


CONTRACT:

CONSTRUCTION


TITLE:
 PROVIDE IMAGING BAY,
 BUILDING 35

LOCATION:
 NATHAN KLINE RESEARCH INSTITUTE
 140 OLD ORANBURG RD.
 ORANBURG, NY


CLIENT:
 NEW YORK STATE
 OFFICE OF MENTAL HEALTH

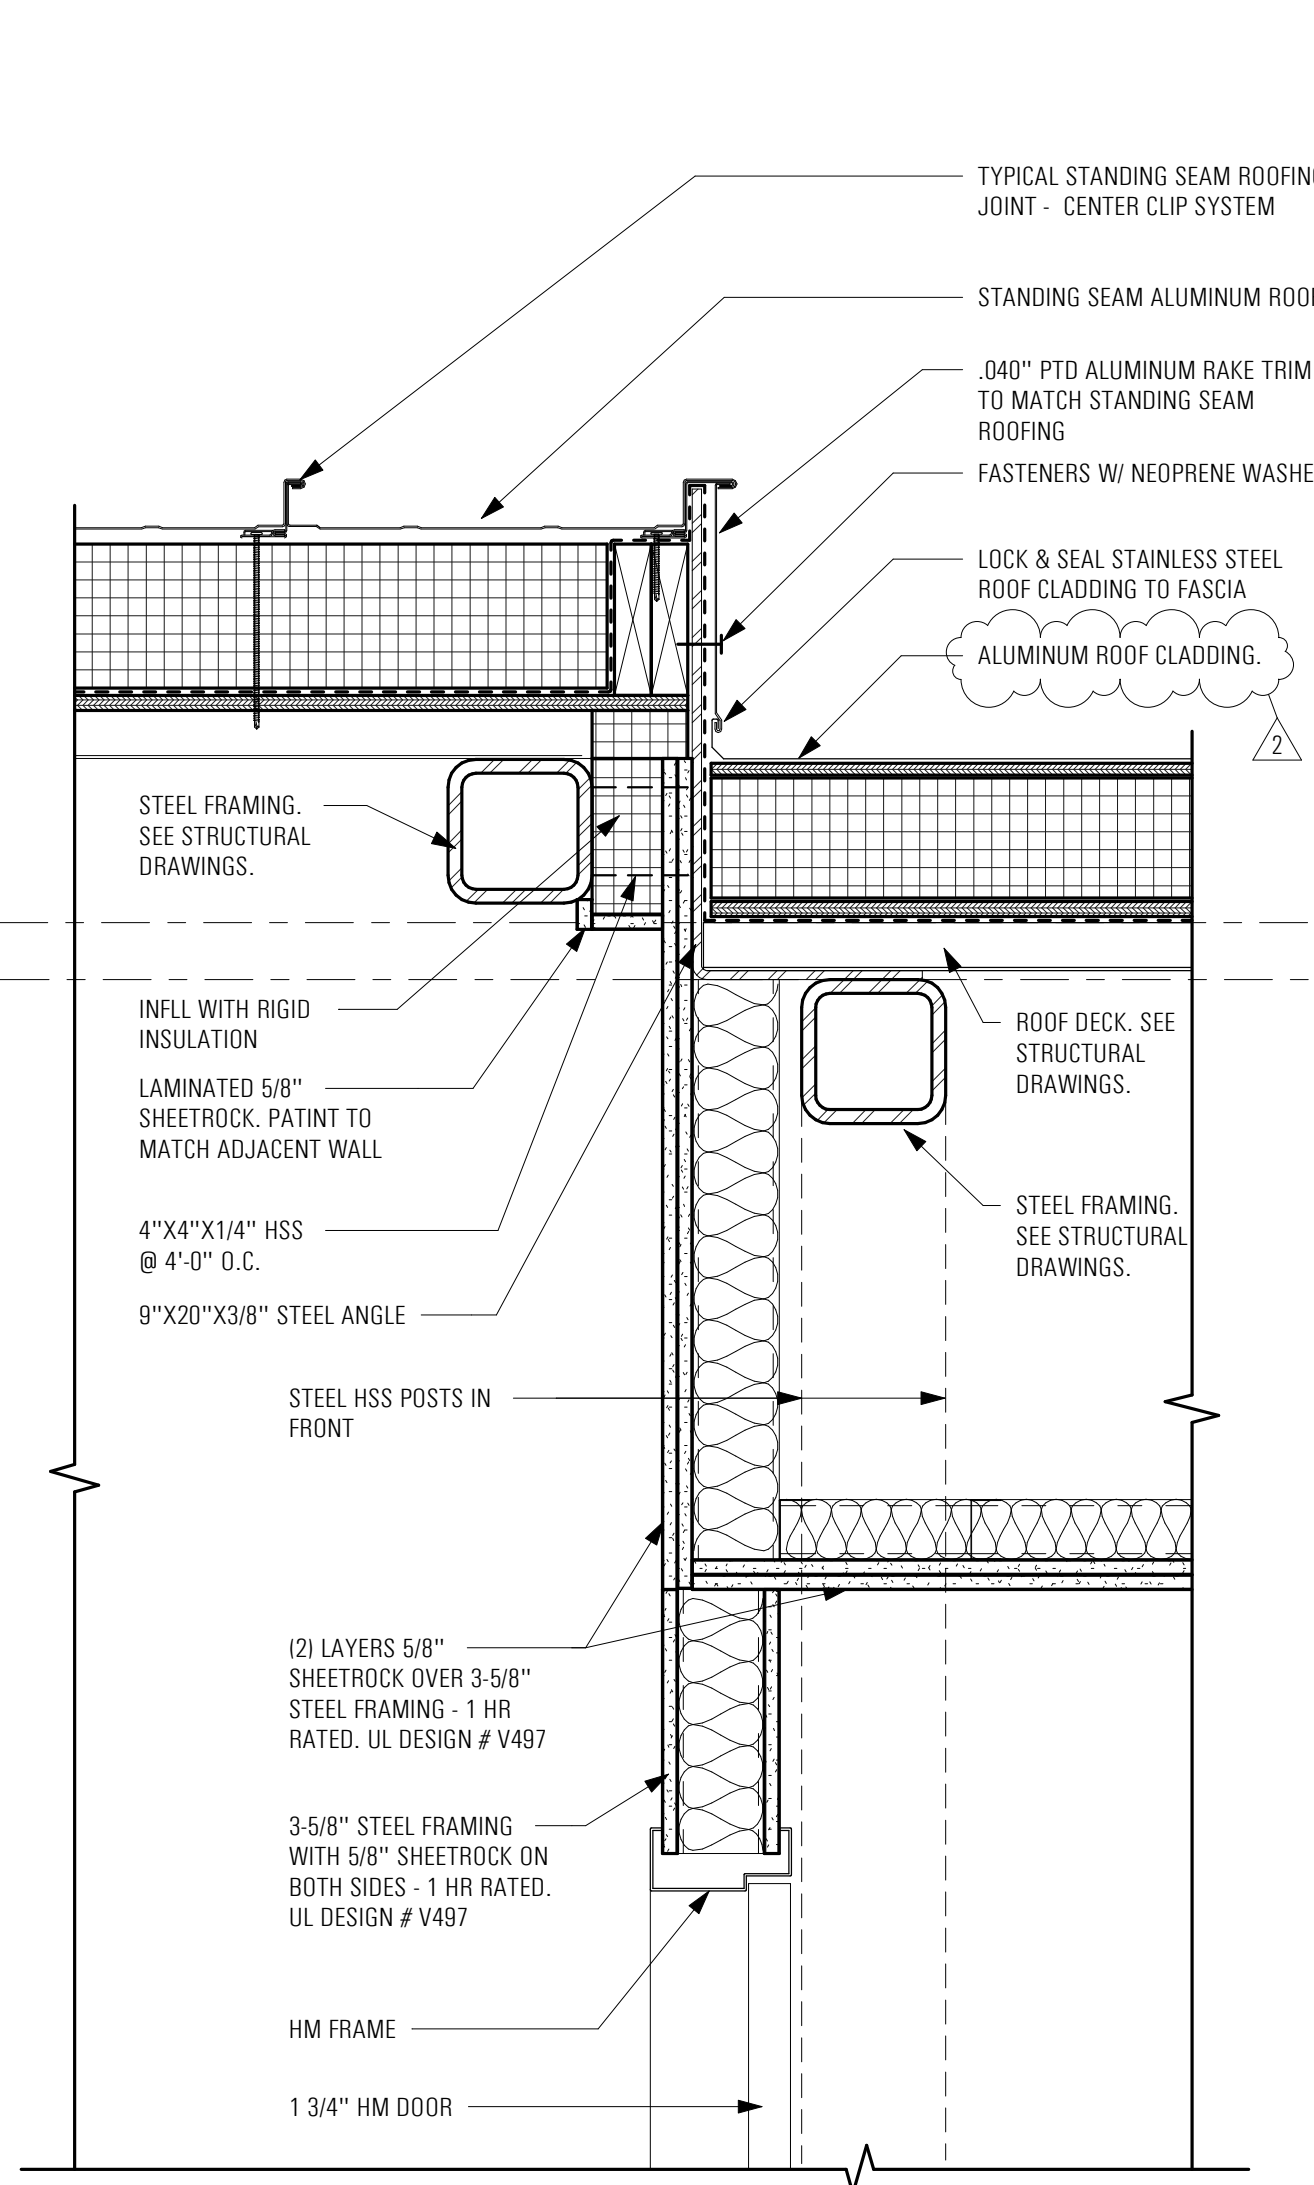


SECTION THRU CORRIDOR NORTH - CEILING TRANSITION SCALE: 1 1/2" = 1'-0" 8

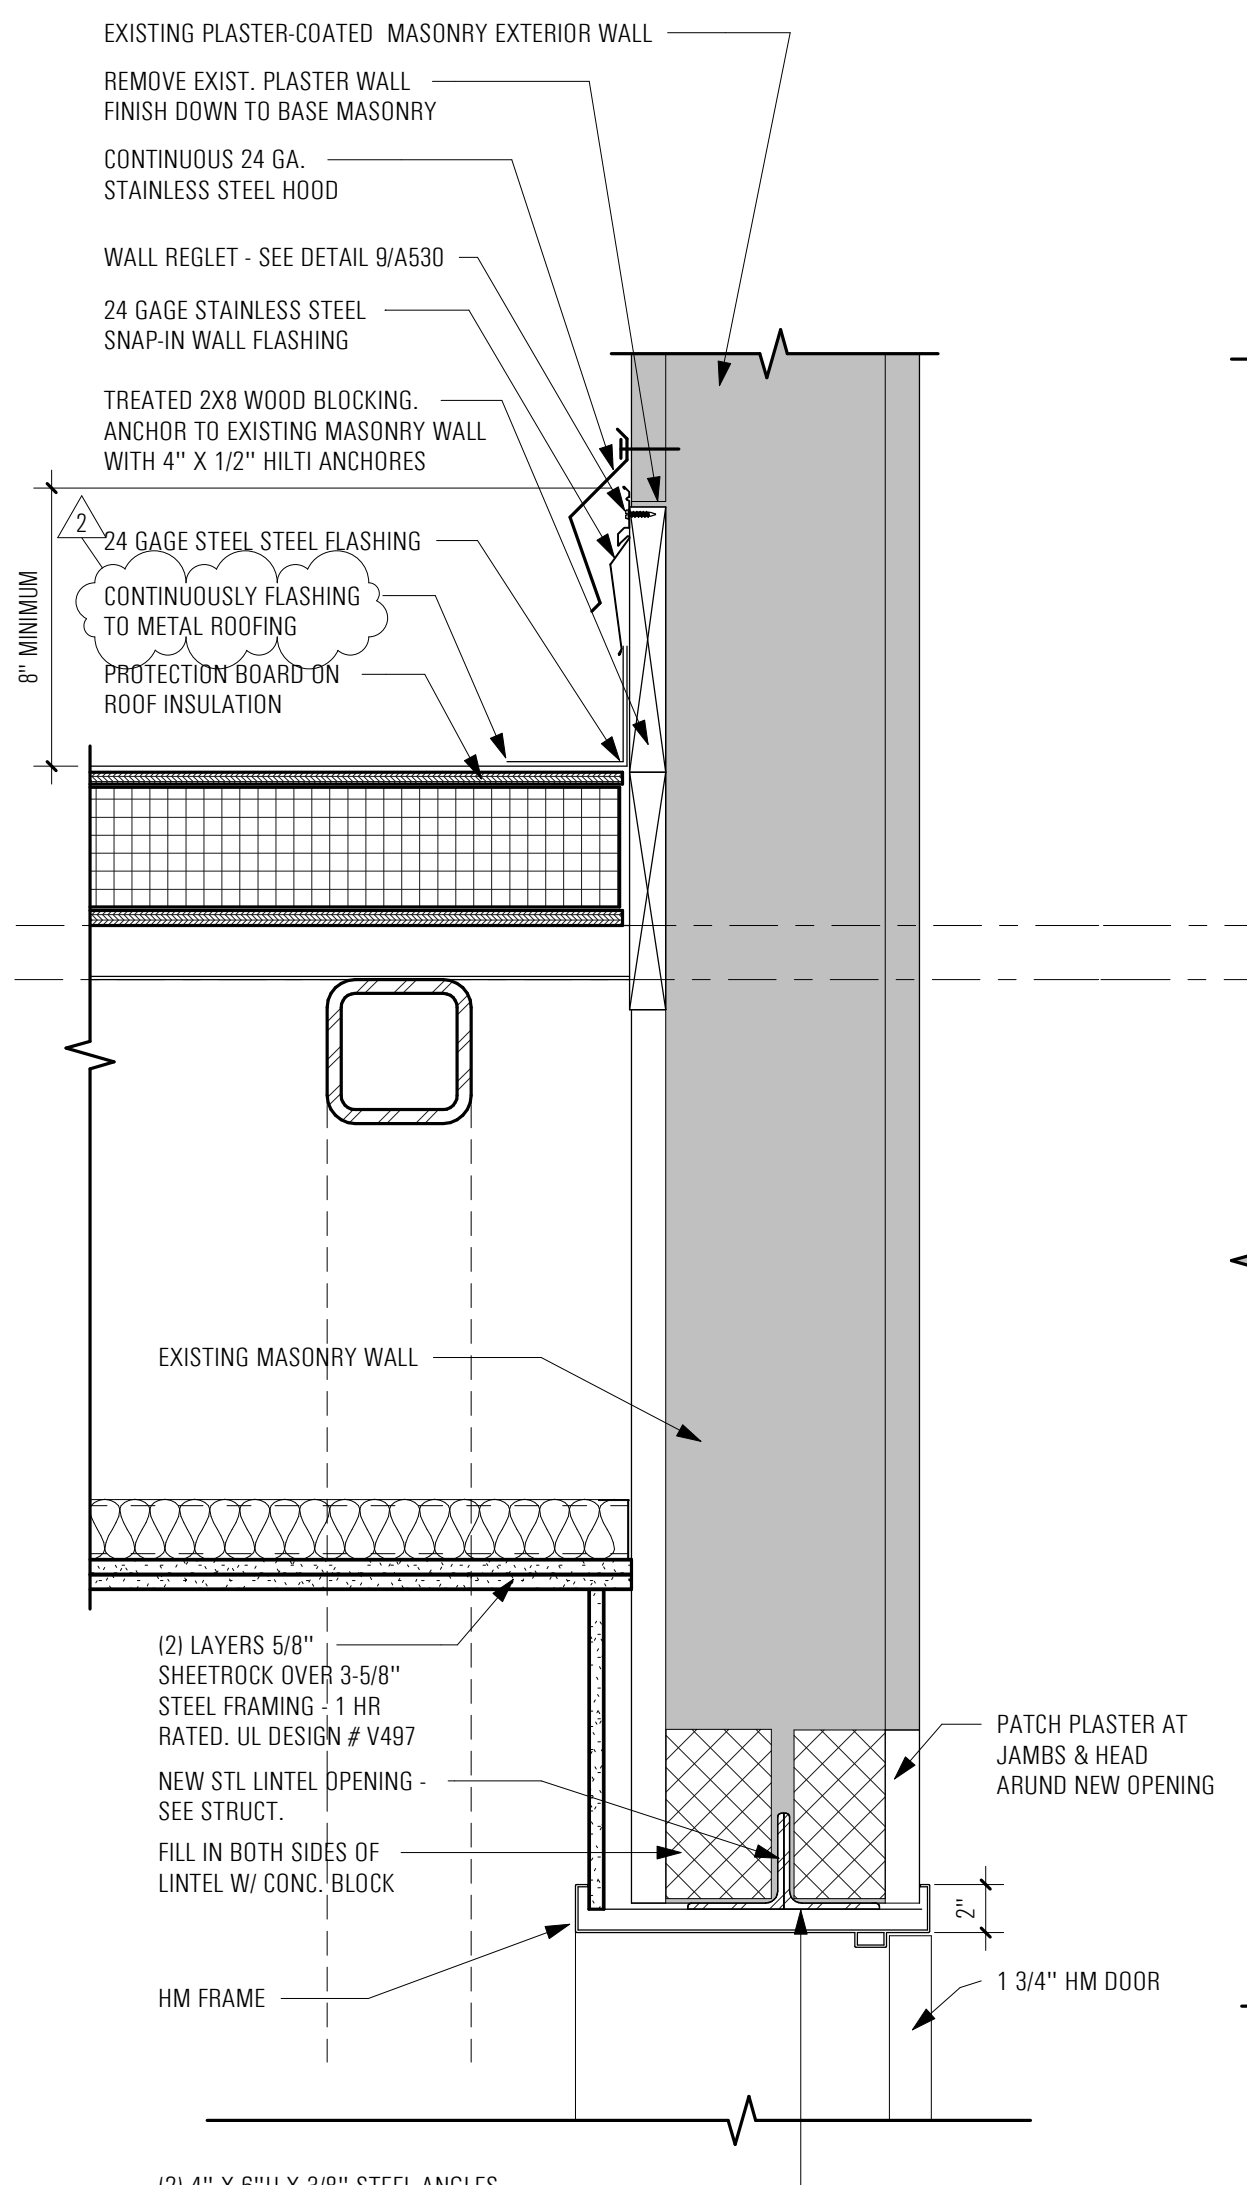


SECTION @ CORRIDOR NORTH - AT EXISTING BUILDING SCALE: 1 1/2" = 1'-0" 6

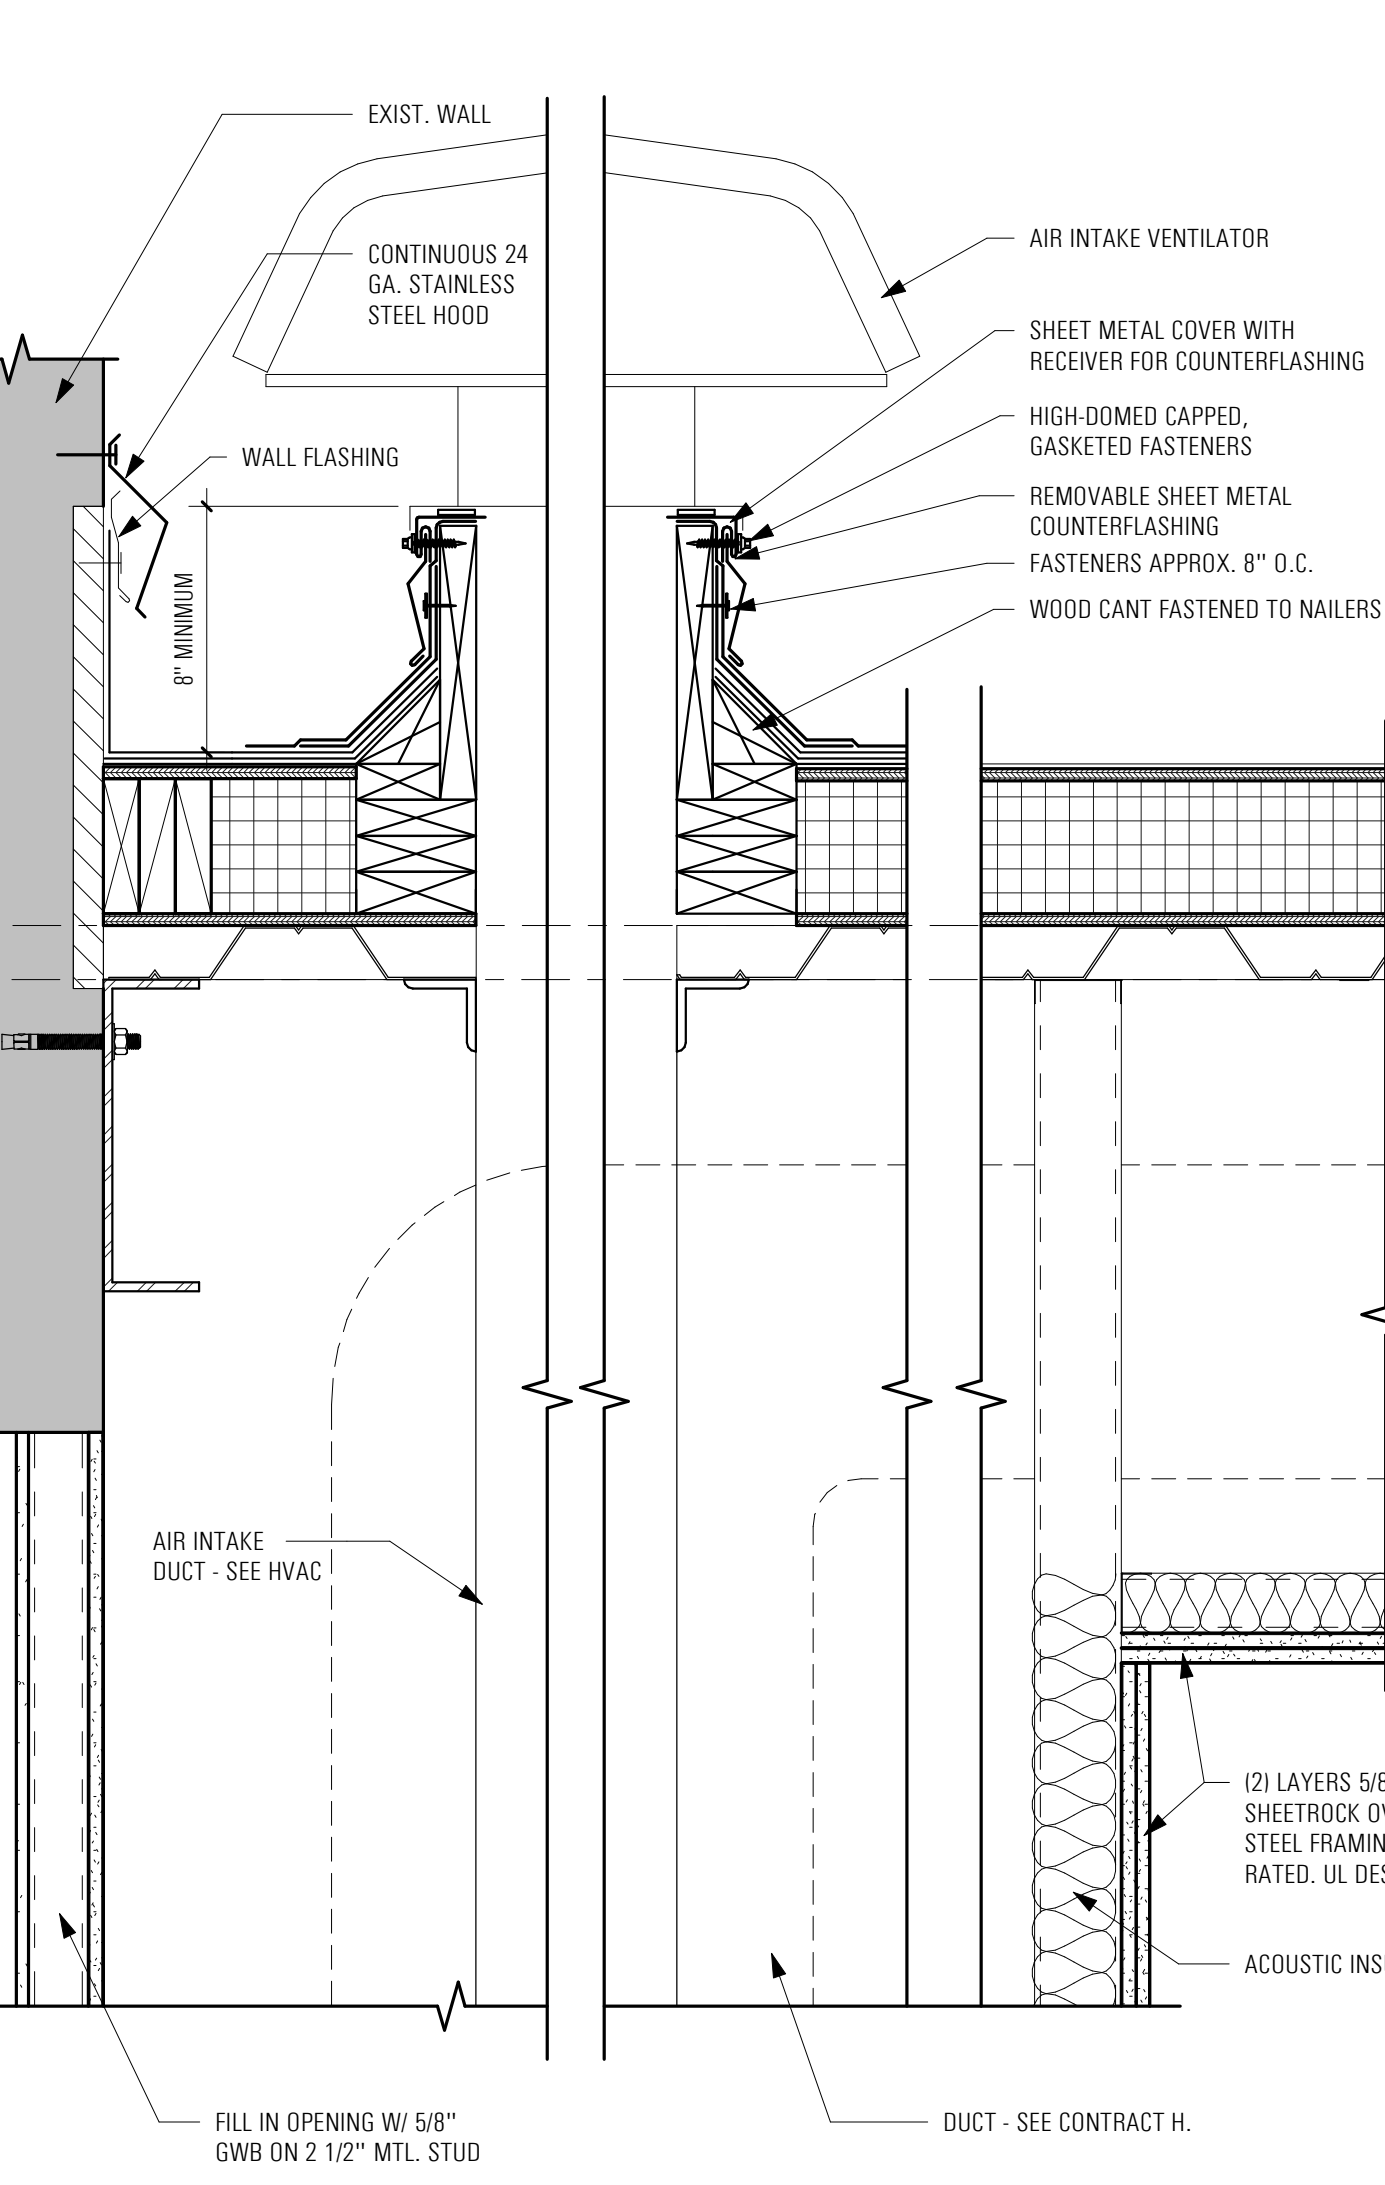


SECTION THRU CORRIDOR NORTH - ROOF ABOVE AREAWAY ENCLOSURE SCALE: 1 1/2" = 1'-0" 4

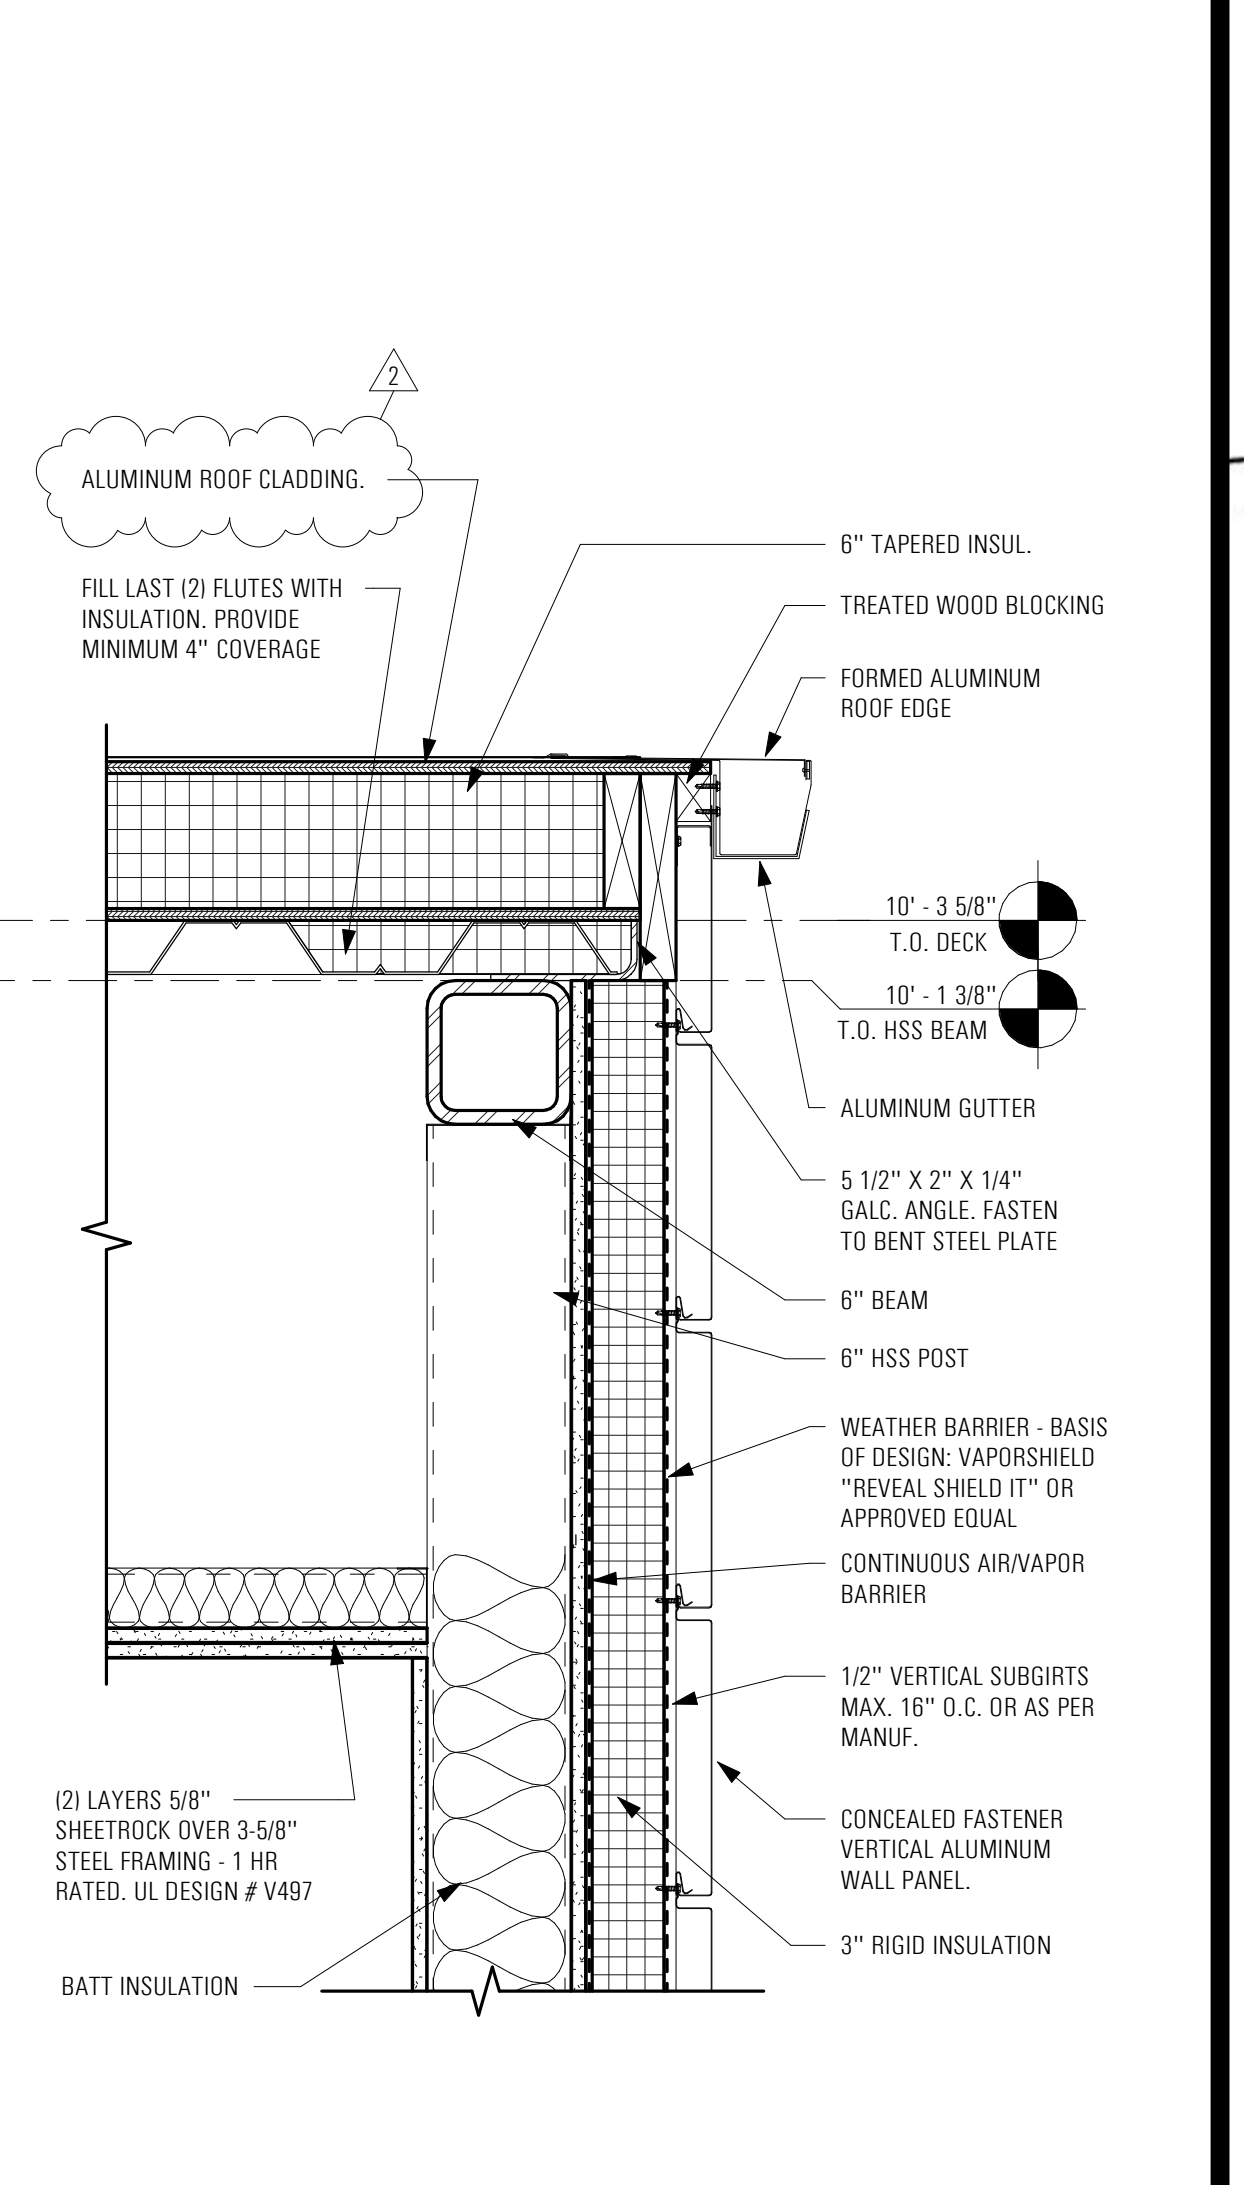


SECTION THRU CORRIDOR NORTH - AT GUTTER SCALE: 1 1/2" = 1'-0" 2

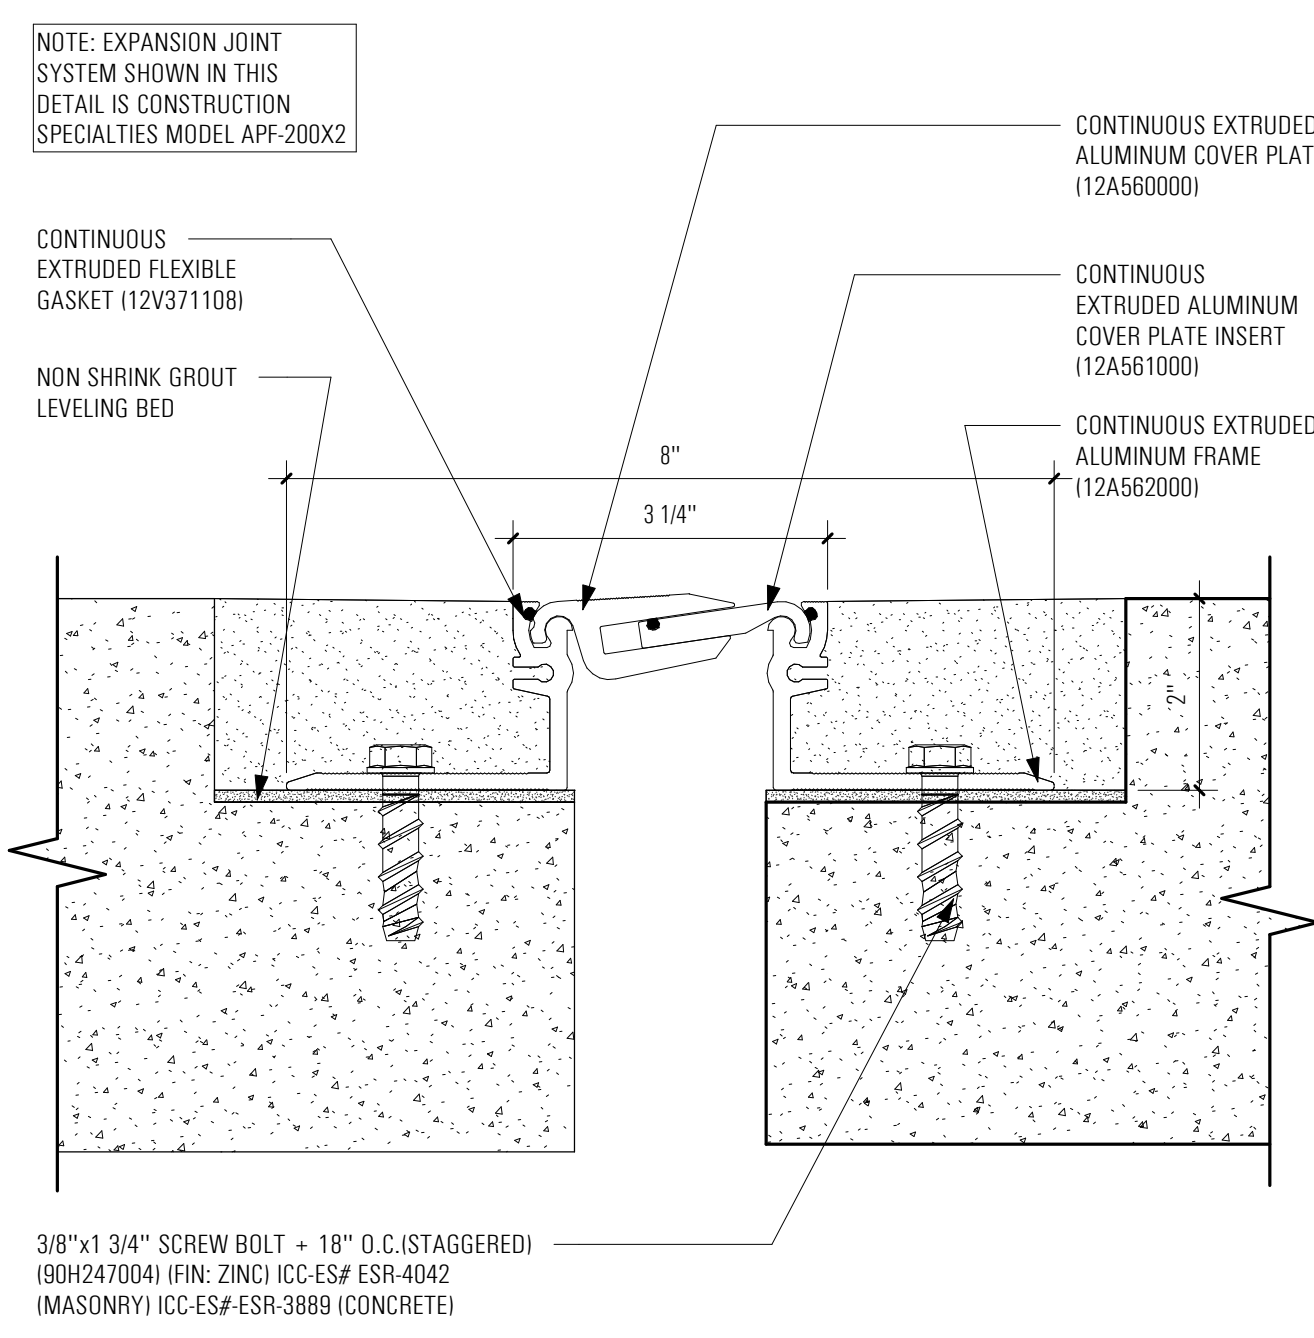


FLOOR EXPANSION JOINT SCALE: 6" = 1'-0" 7

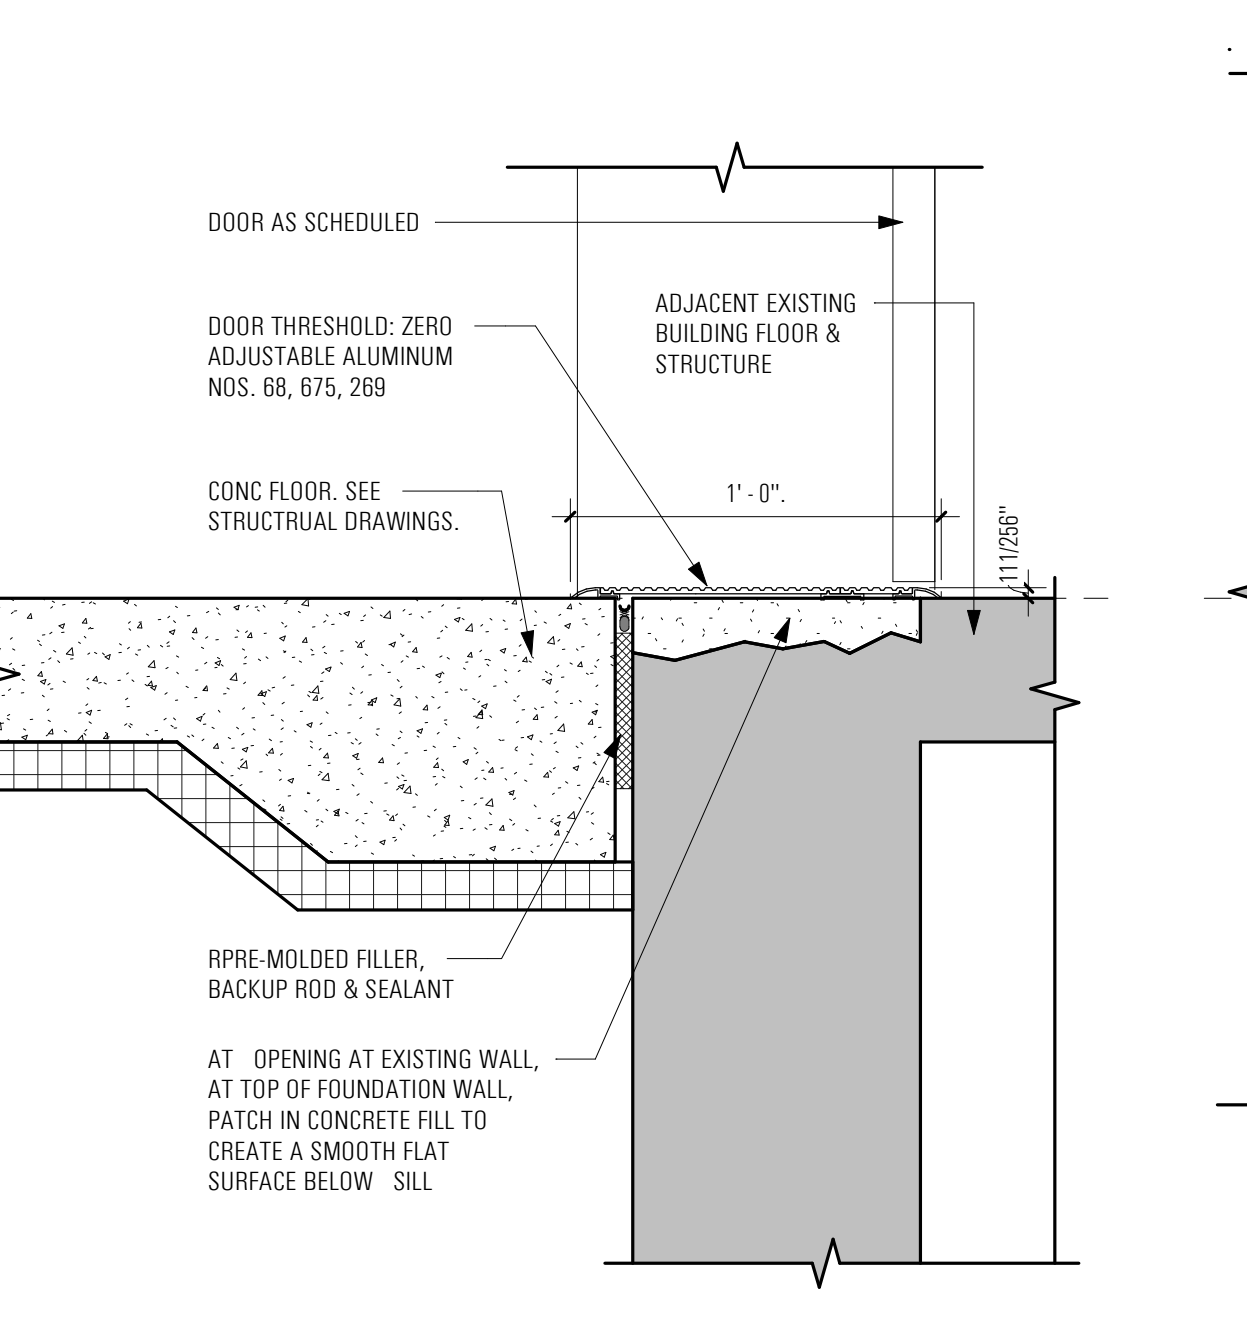

SECTION THRU CORRIDOR NORTH - DOOR SILL EXISTING BUILDING SCALE: 1 1/2" = 1'-0" 5

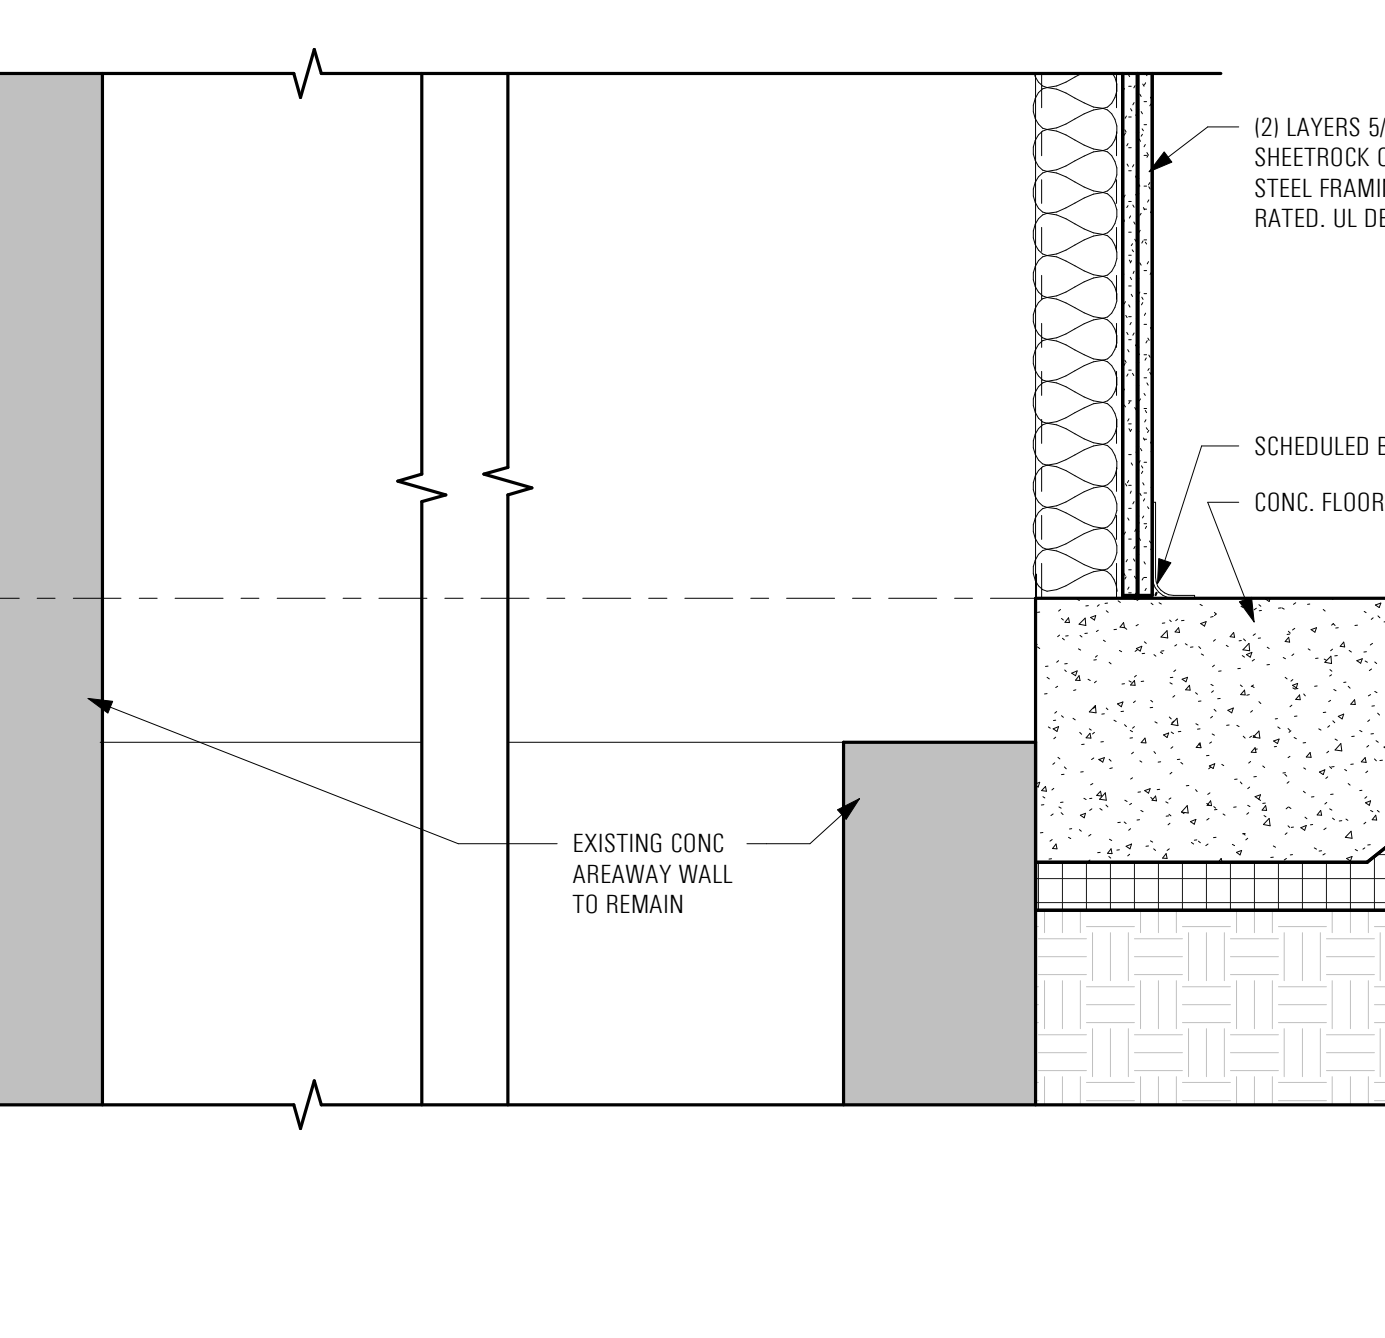

SECTION THRU CORRIDOR NORTH - AREAWAY ENCLOSURE BOTTOM SCALE: 1 1/2" = 1'-0" 3

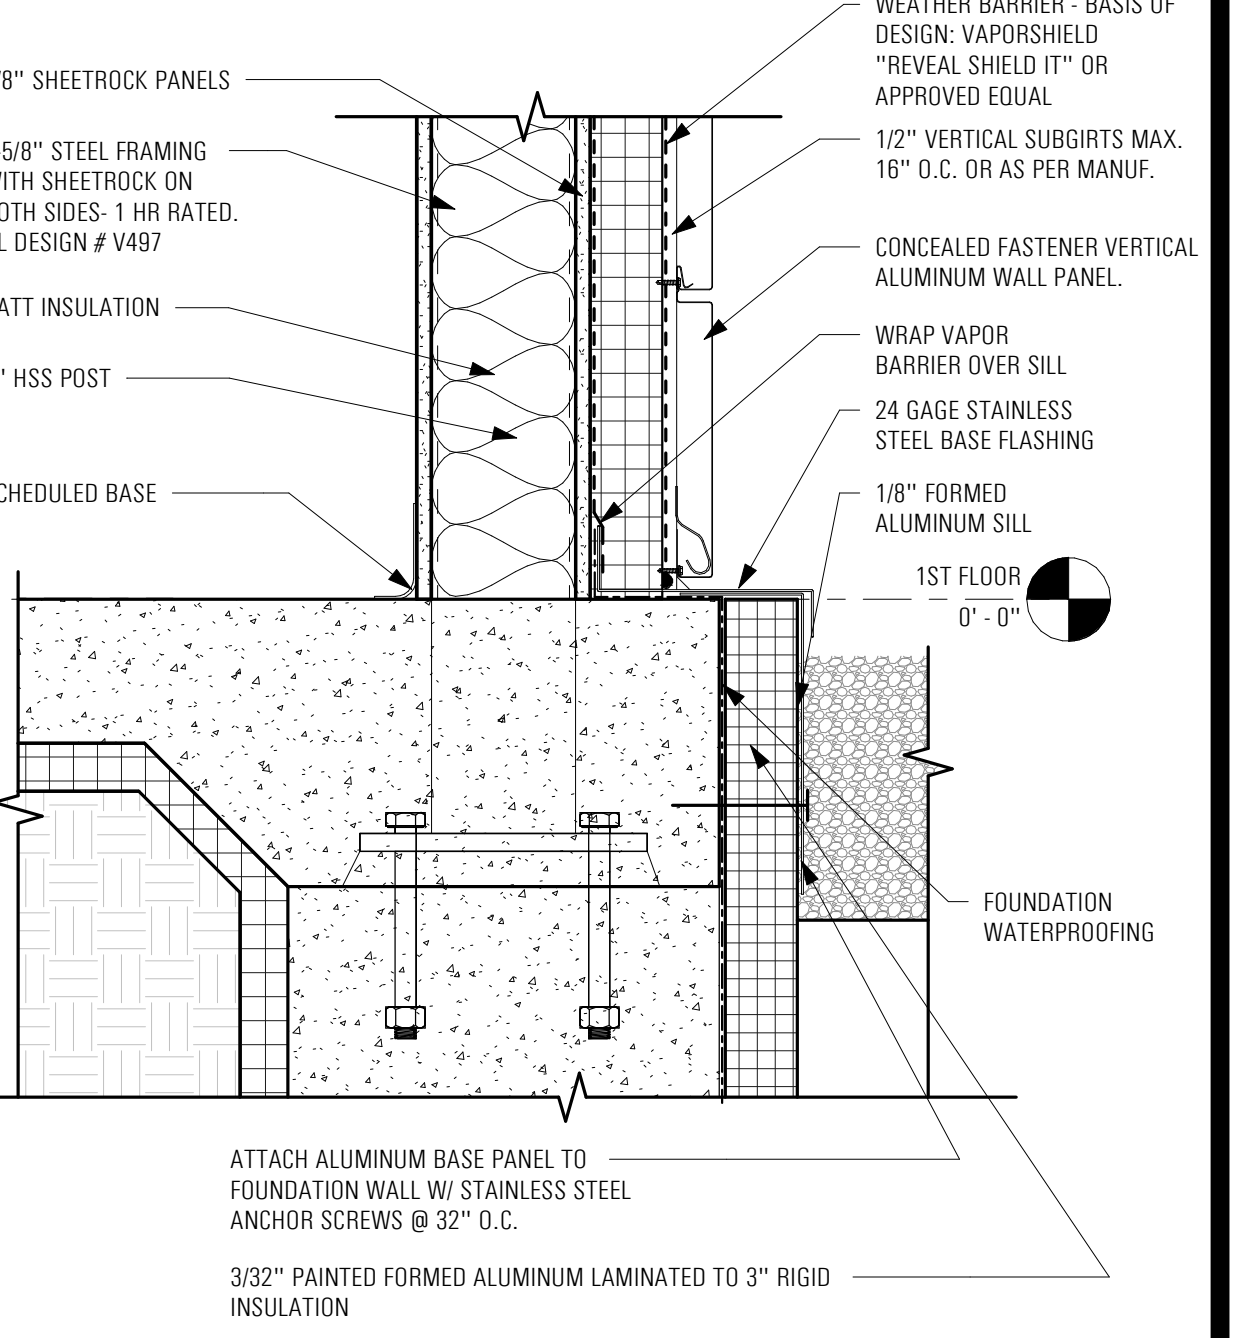

SECTION THRU CORRIDOR NORTH - AT BASE SCALE: 1 1/2" = 1'-0" 1

MARK	DATE	DESCRIPTION
2	12/01/2025	ADDENDUM 6
1	11/14/2025	ADDENDUM 4
	06/18/2025	BID DOCUMENT
PROJECT NUMBER:		46218-C,H,P,E
DESIGNED BY:		DP
DRAWN BY:		BL
FIELD CHECK:		
APPROVED:		
SHEET TITLE:		EXTERIOR DETAILS
DRAWING NUMBER:		A-502

CONSULTANTS:

CERTIFICATE OF AUTHORIZATION #:



EXPIRATION DATE: 06/30/2027
 ARCHITECT:
JACK L. GORDON ARCHITECTS
 MEP/FP/FA/ENGINEER:
LEGACY ENGINEERS
 SITE/CIVIL ENGINEER:
HAYDUK ENGINEERING
 GEOTECHNICAL ENGINEER:
HARTLAND ENGINEERING
 STRUCTURAL ENGINEER:
YSRAEL A. SEINUK, PC
 IT CONSULTANT:
CERAMI & ASSOCIATES

ENERGY CODE STATEMENT
 TO THE BEST OF THE ARCHITECT/ENGINEER'S KNOWLEDGE, BELIEF AND PROFESSIONAL JUDGEMENT, THESE PLANS AND/OR SPECIFICATIONS ARE IN COMPLIANCE WITH THE 2020 NEW YORK STATE ENERGY CODE.
 2020 NEW YORK STATE FIRE CODE AND BUILDING CODE
 1. TO THE BEST OF THE KNOWLEDGE, BELIEF AND PROFESSIONAL JUDGEMENT OF THE LICENSED PROFESSIONAL SEALING THESE PLANS AND SPECIFICATIONS, THESE PLANS ARE IN COMPLIANCE WITH THE 2020 NEW YORK STATE FIRE CODE AND BUILDING CODE.

WARNING:
 THE ALTERATION OF THIS MATERIAL IN ANY WAY, UNLESS DONE UNDER THE DIRECTION OF A COMPARABLE PROFESSIONAL, I.E. ARCHITECT FOR AN ARCHITECT, ENGINEER FOR AN ENGINEER OR LANDSCAPE ARCHITECT FOR A LANDSCAPE ARCHITECT, IS A VIOLATION OF THE NEW YORK STATE EDUCATION LAW AND/OR REGULATIONS AND IS A CLASS "A" MISDEMEANOR.

REGISTRATION EXPIRES:

CONTRACT:

CONSTRUCTION

TITLE:
**PROVIDE IMAGING BAY,
 BUILDING 35**

LOCATION:
**NATHAN KLINE RESEARCH INSTITUTE
 140 OLD ORANGEBURG RD.
 ORANGEBURG, NY**

CLIENT:
**NEW YORK STATE
 OFFICE OF MENTAL HEALTH**

MARK	DATE	DESCRIPTION
2	12/01/2025	ADDENDUM 6
1	11/14/2025	ADDENDUM 4
	06/18/2025	BID DOCUMENT

PROJECT NUMBER: 46218-C,H,P,E

DESIGNED BY: DP

DRAWN BY: BL

FIELD CHECK:


APPROVED:

SHEET TITLE:


EXTERIOR DETAILS

DRAWING NUMBER:
A-504


SHEET 78 OF 176

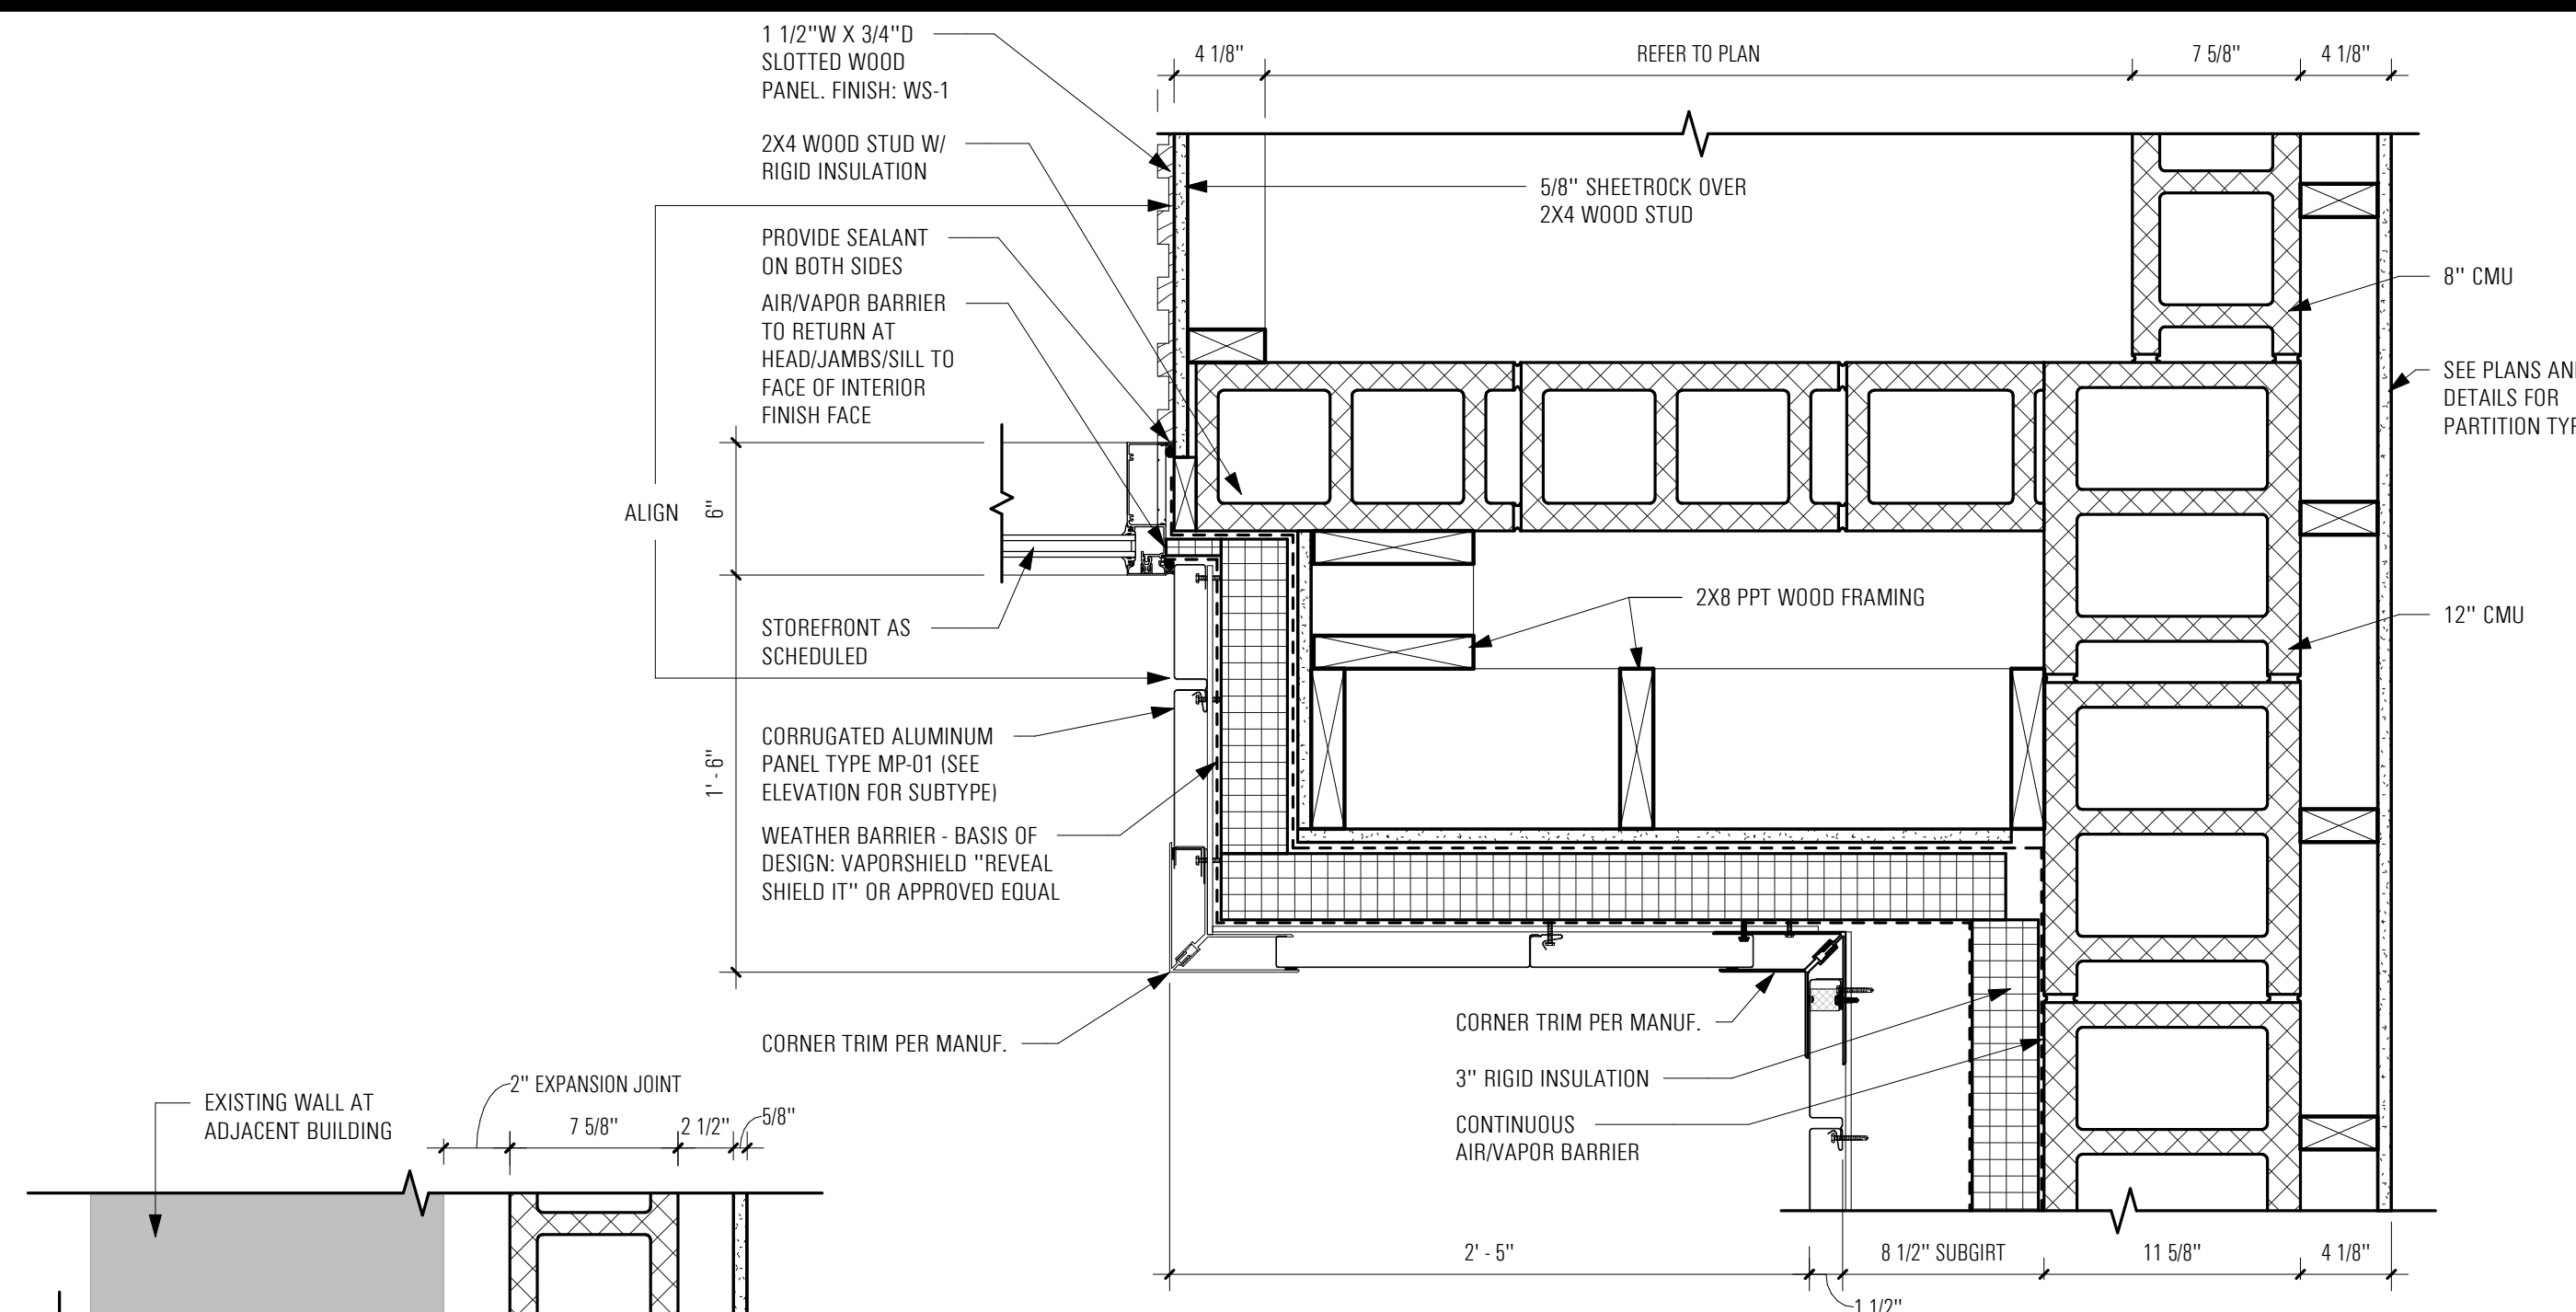


PLAN DETAIL @ WAITING ROOM WINDOW - EAST SIDE SCALE: 1 1/2" = 1'-0" 10

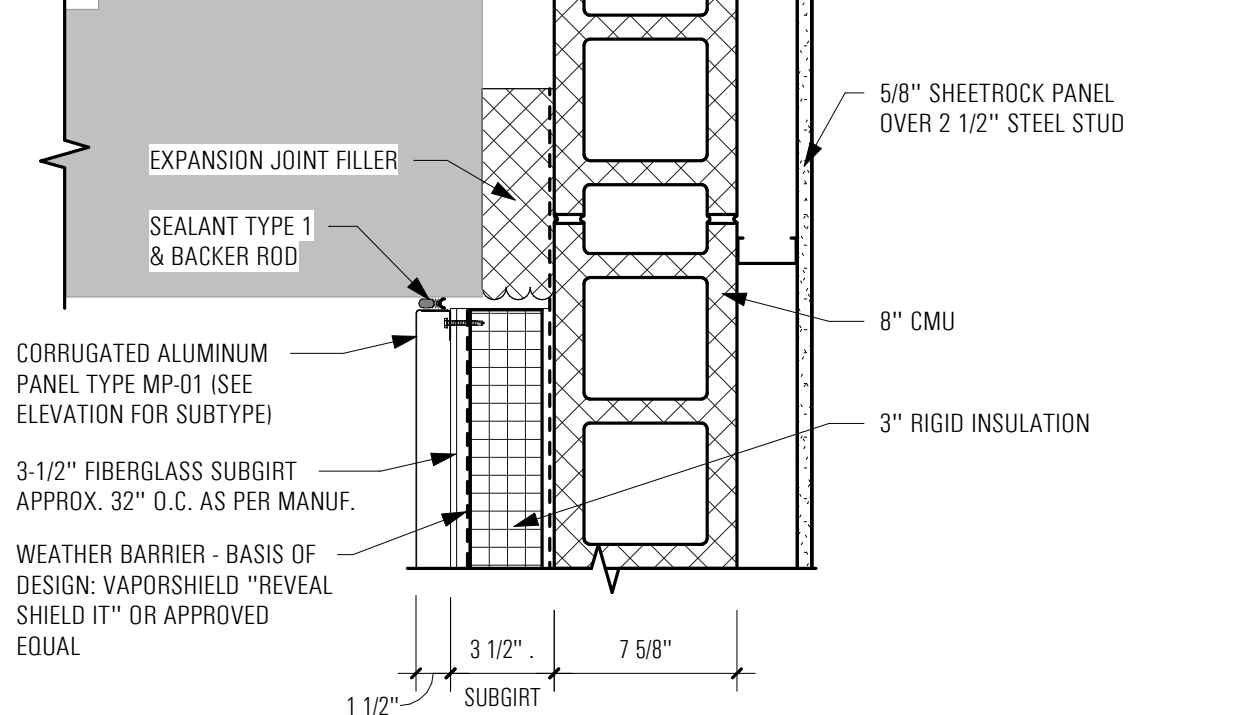


EXPANSION JOINT AT WAITING ROOM WEST EXTERIOR WALL SCALE: 1 1/2" = 1'-0" 13

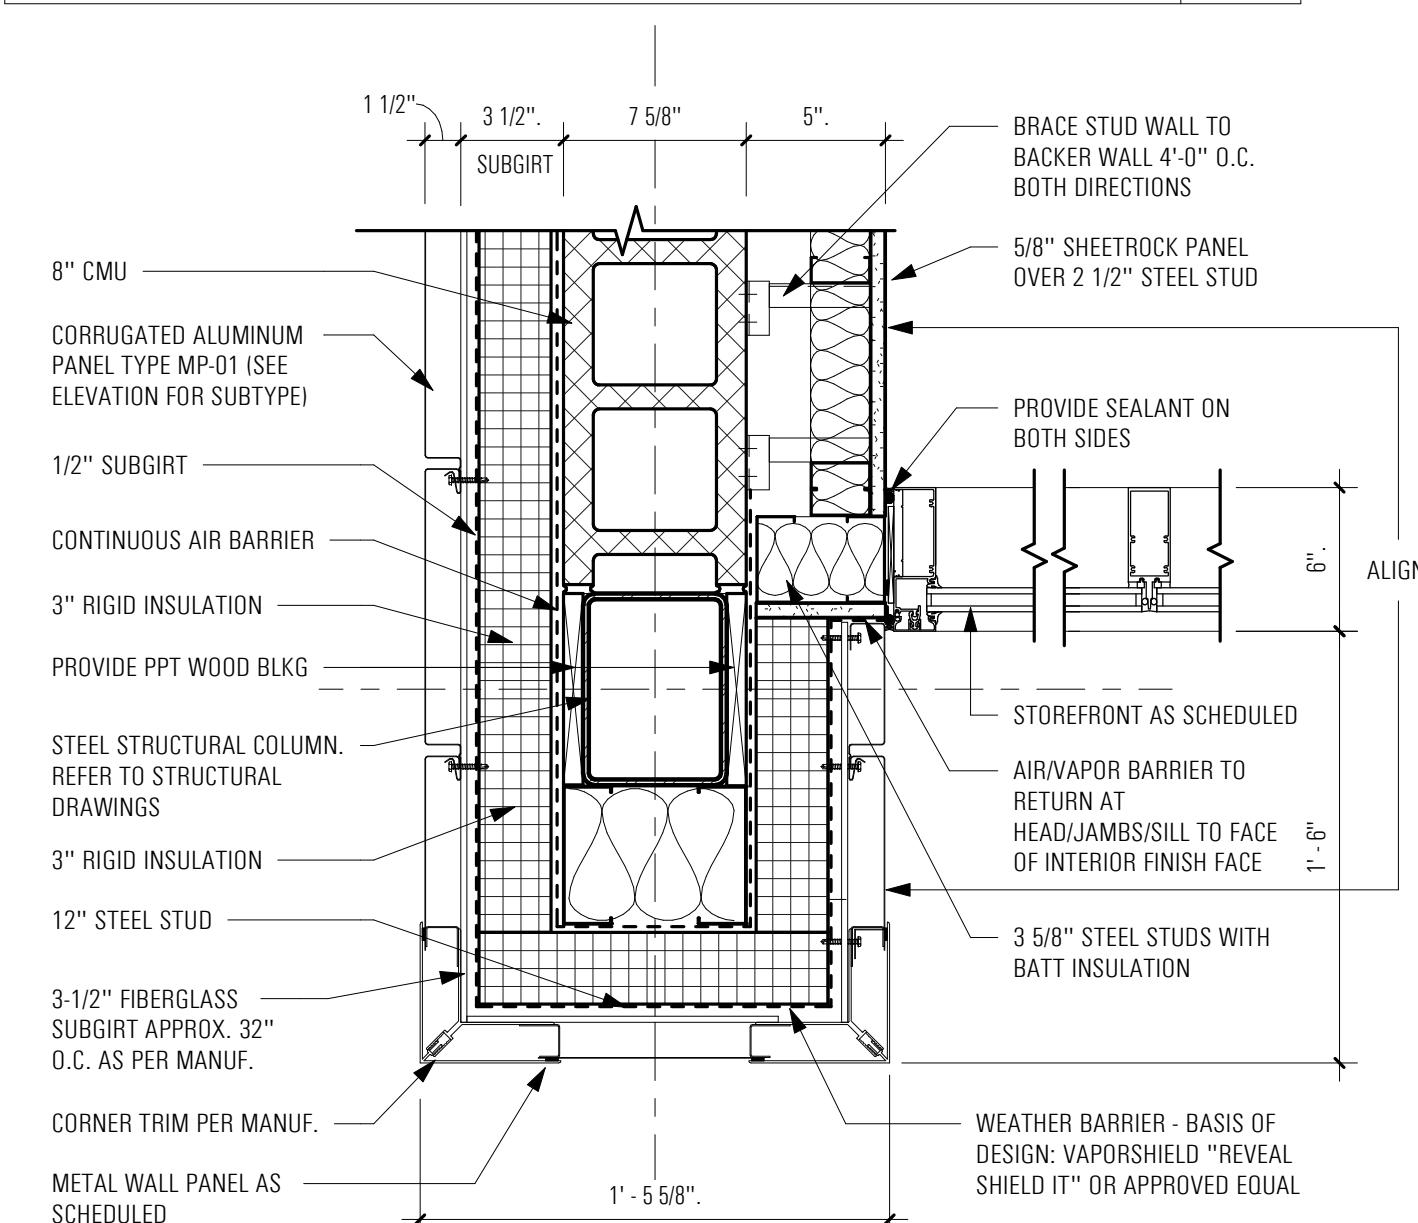


PLAN DETAIL @ WAITING ROOM WINDOW - WEST SIDE SCALE: 1 1/2" = 1'-0" 12

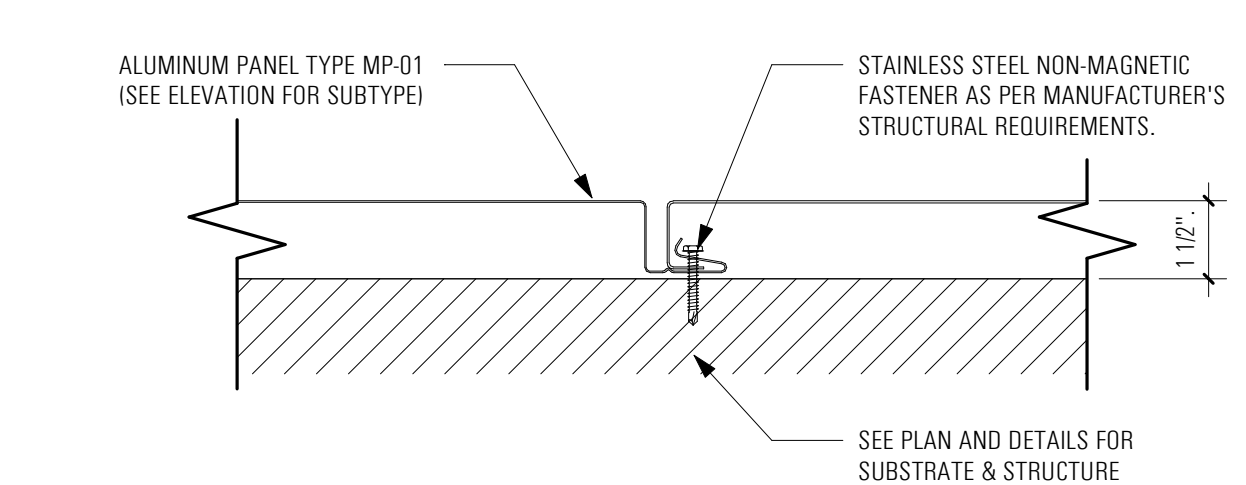


TYPICAL PANEL JOINT DETAIL SCALE: 3" = 1'-0" 11

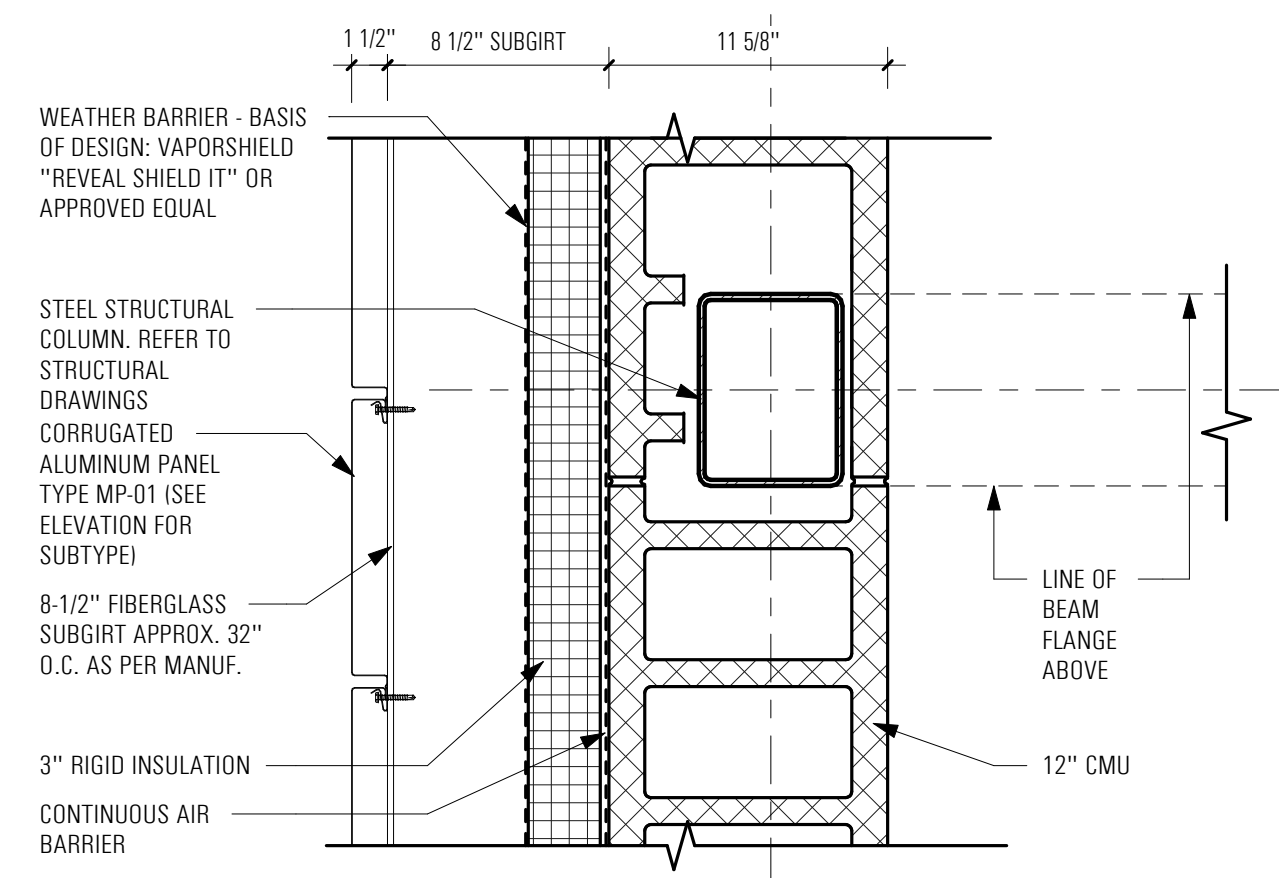


PLAN DETAIL - METAL WALL PANEL @ IMAGERY LOW WALL WEST SCALE: 1 1/2" = 1'-0" 9

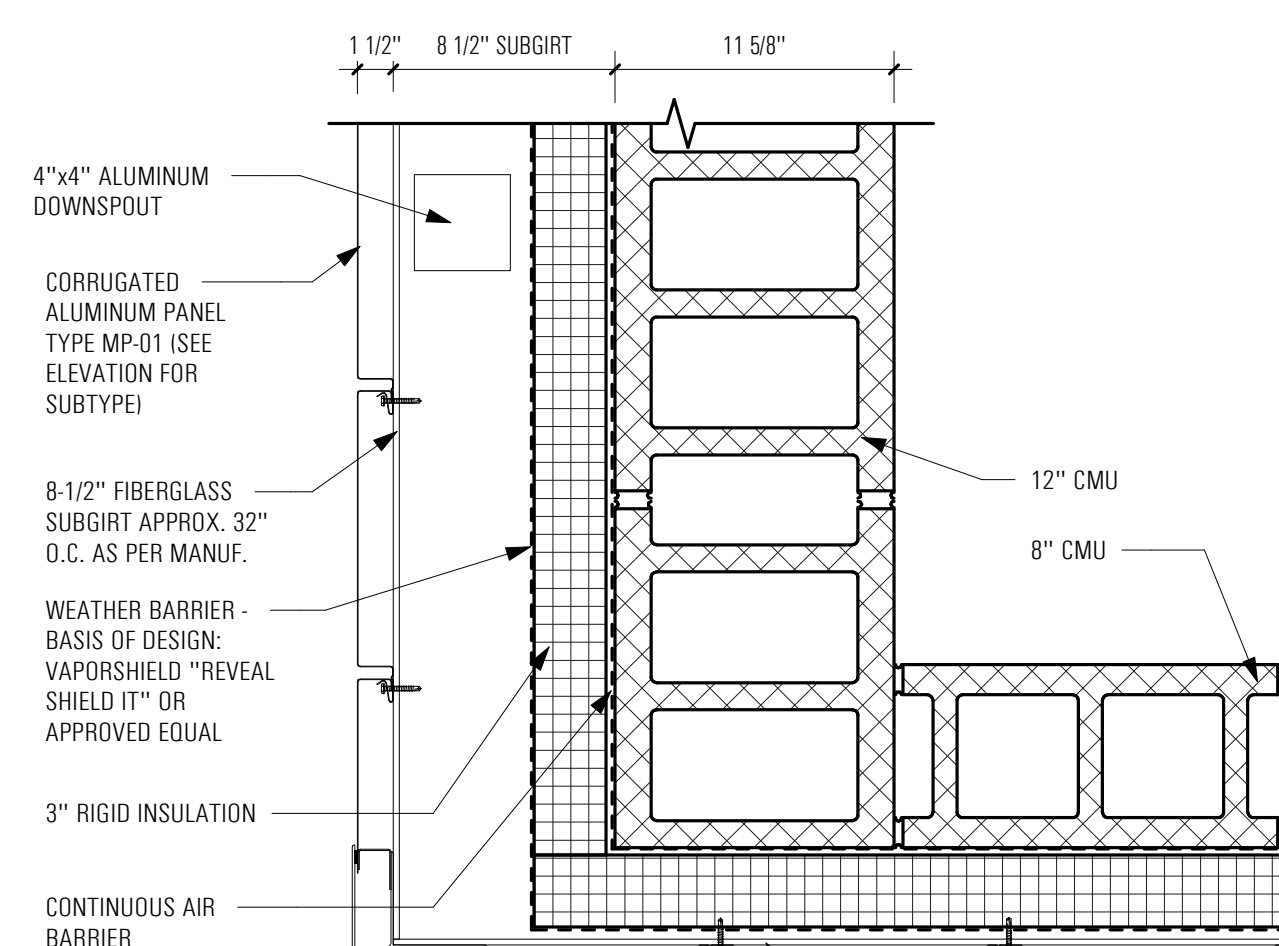


PLAN DETAIL - METAL WALL PANEL @ IMAGERY LOW WALL EXTERNAL CORNER - SOUTH WEST SCALE: 1 1/2" = 1'-0" 8

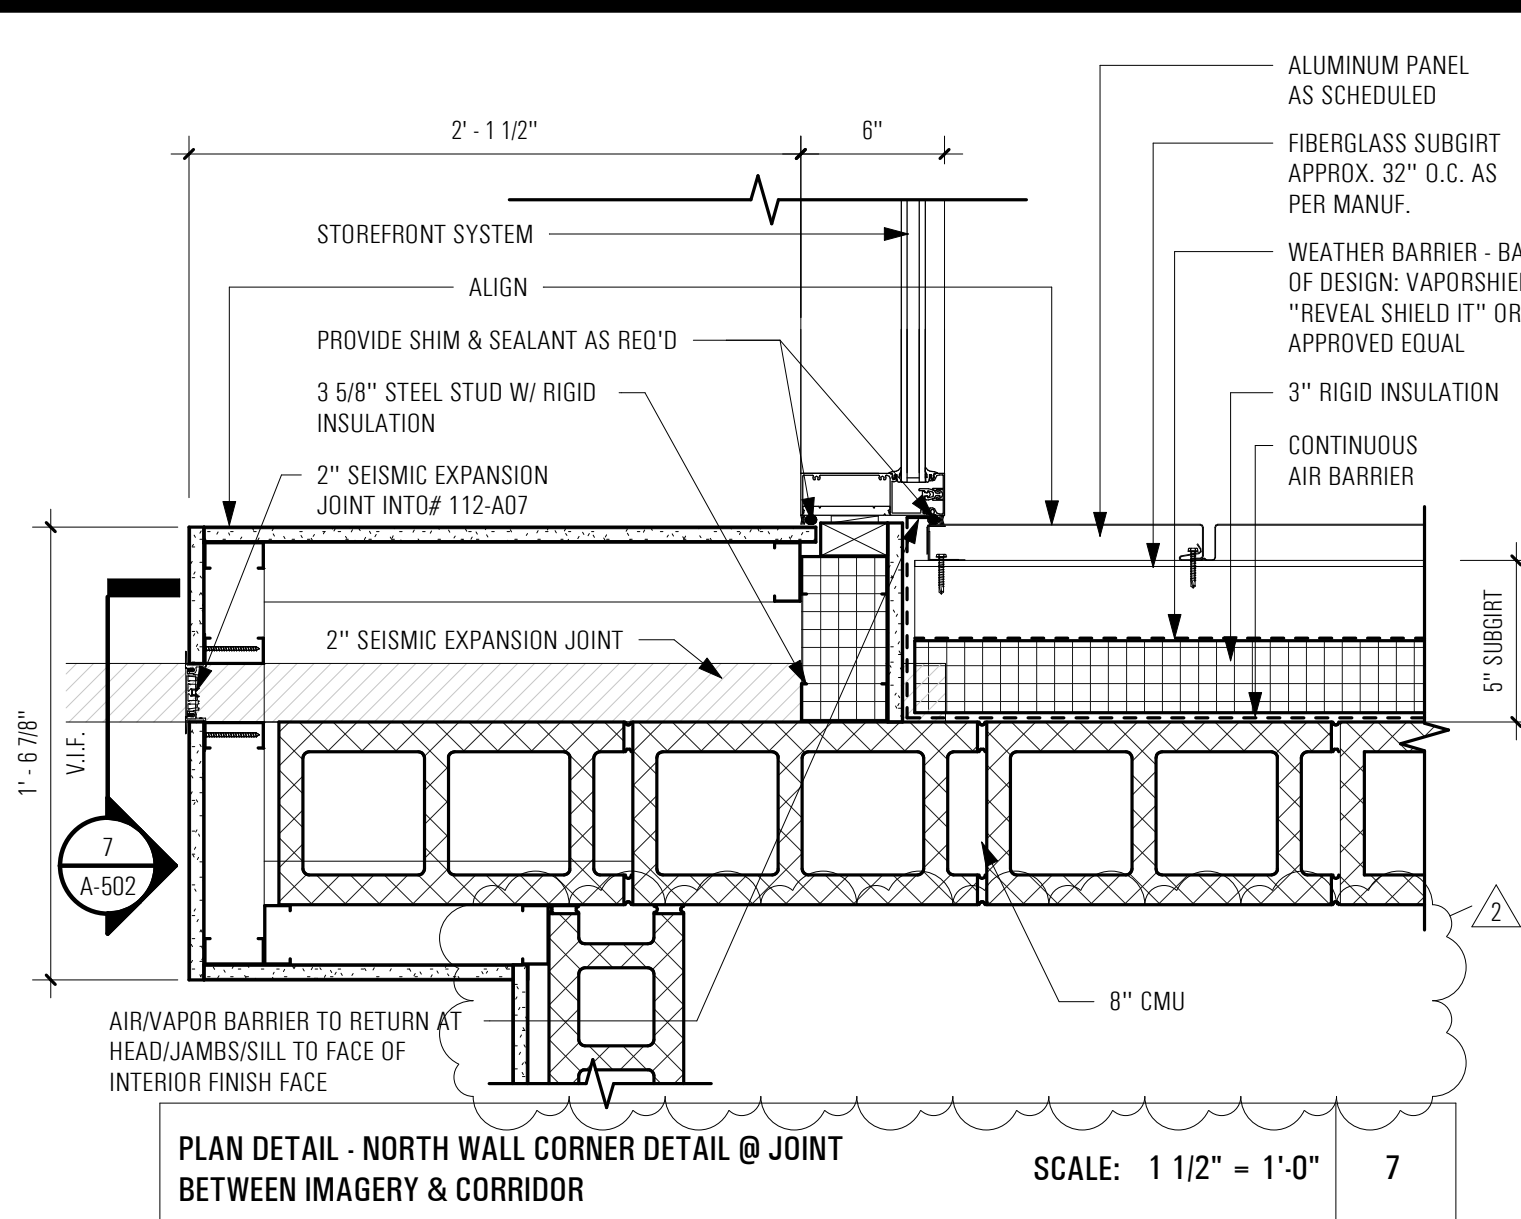


PLAN DETAIL - NORTH WALL CORNER DETAIL @ JOINT BETWEEN IMAGERY & CORRIDOR SCALE: 1 1/2" = 1'-0" 7

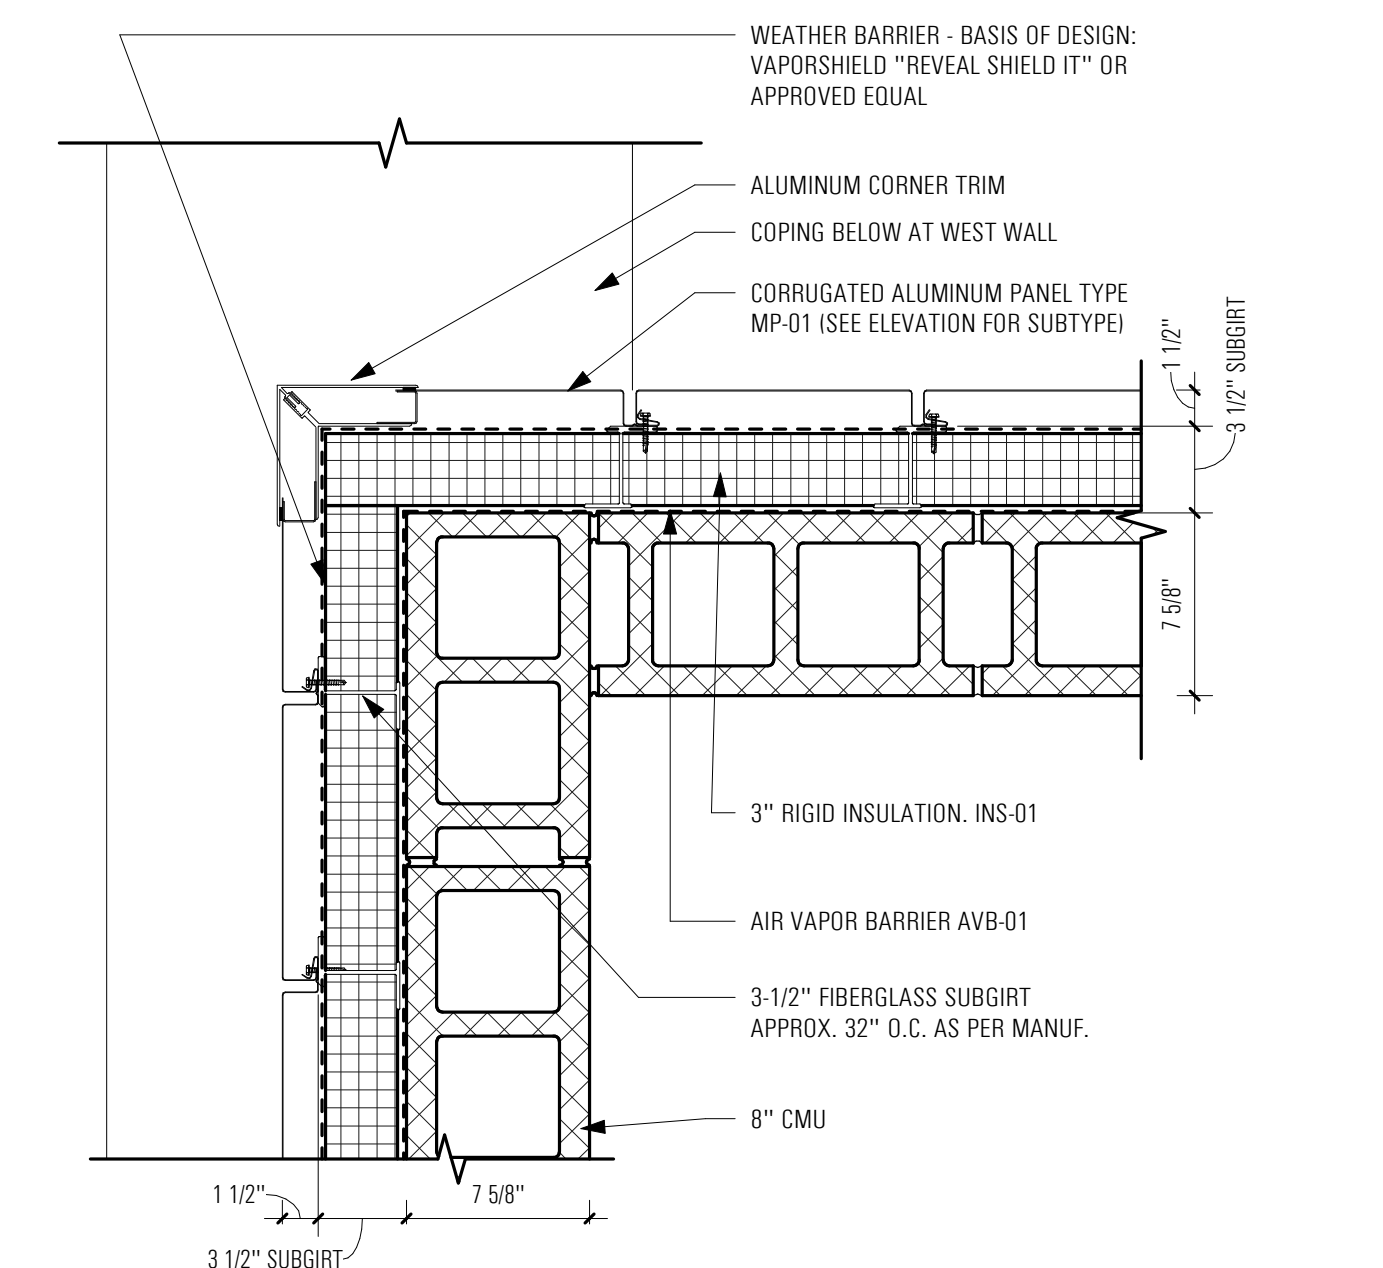


PLAN DETAIL - METAL WALL PANEL @ HIGH WALLS ABOVE MRI ROOM SCALE: 1 1/2" = 1'-0" 6

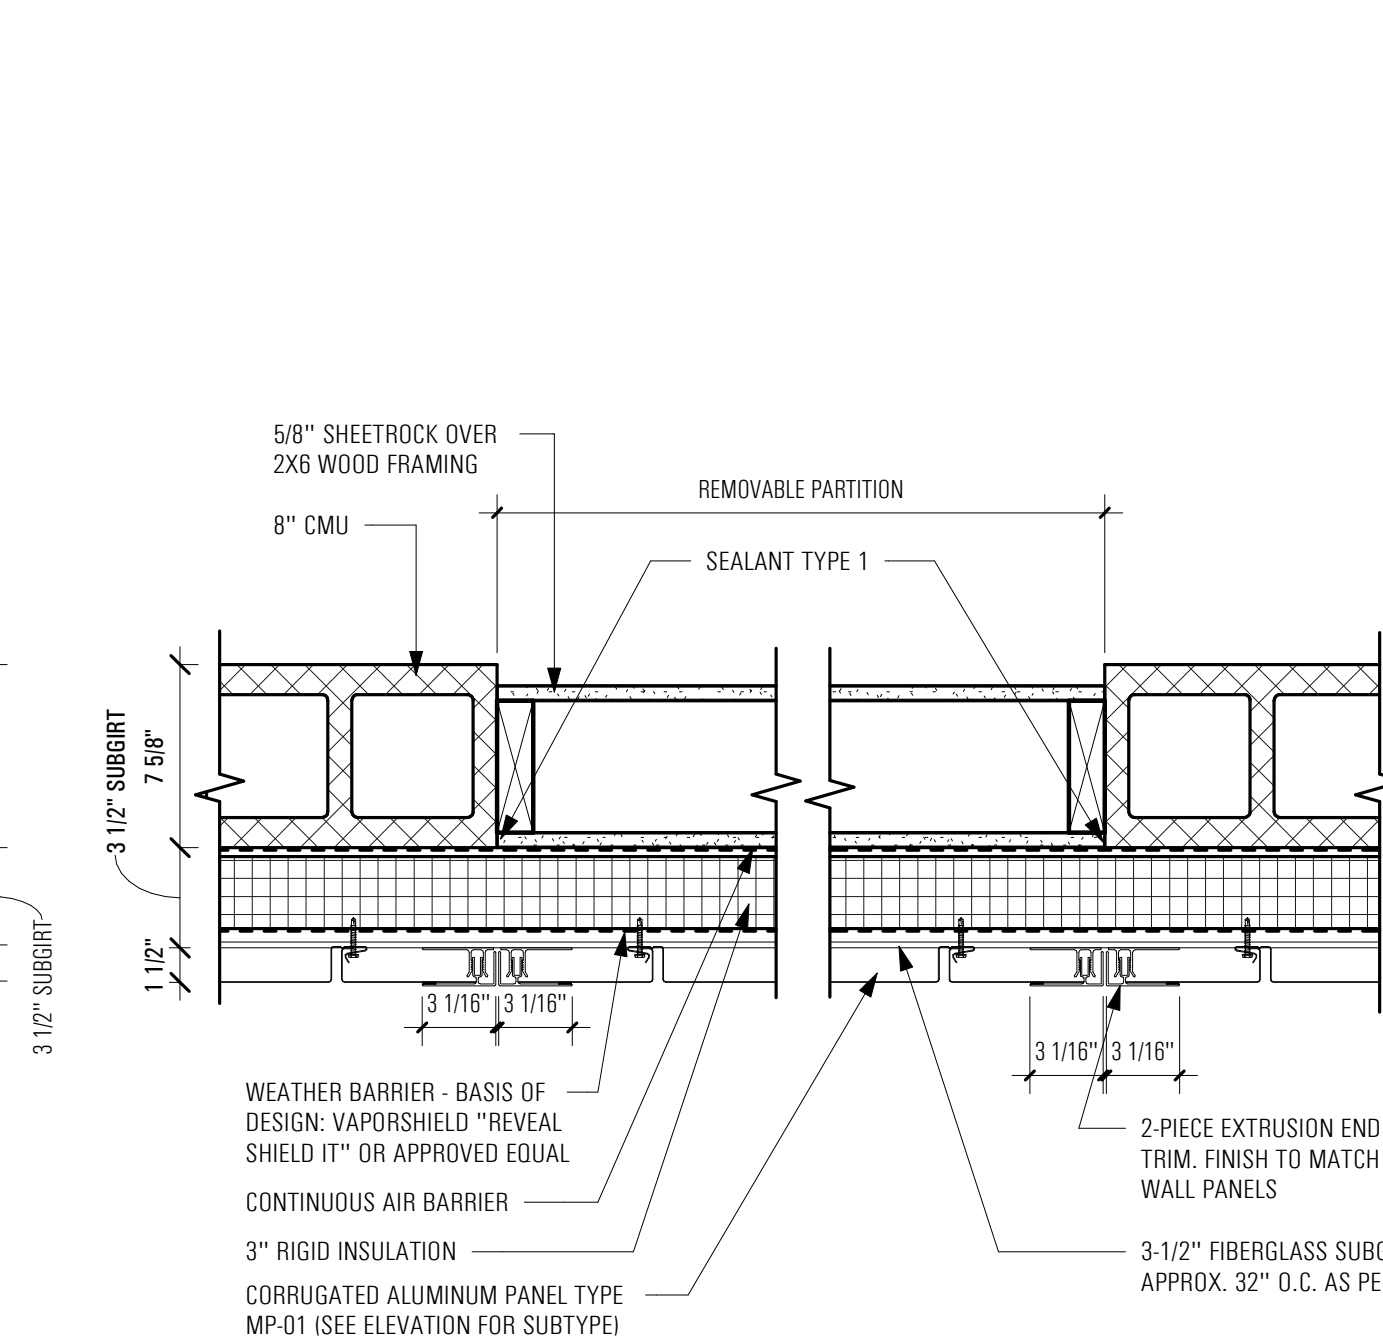


PLAN DETAIL - IMAGERY SOUTH @ REMOVABLE WALL SCALE: 1 1/2" = 1'-0" 4

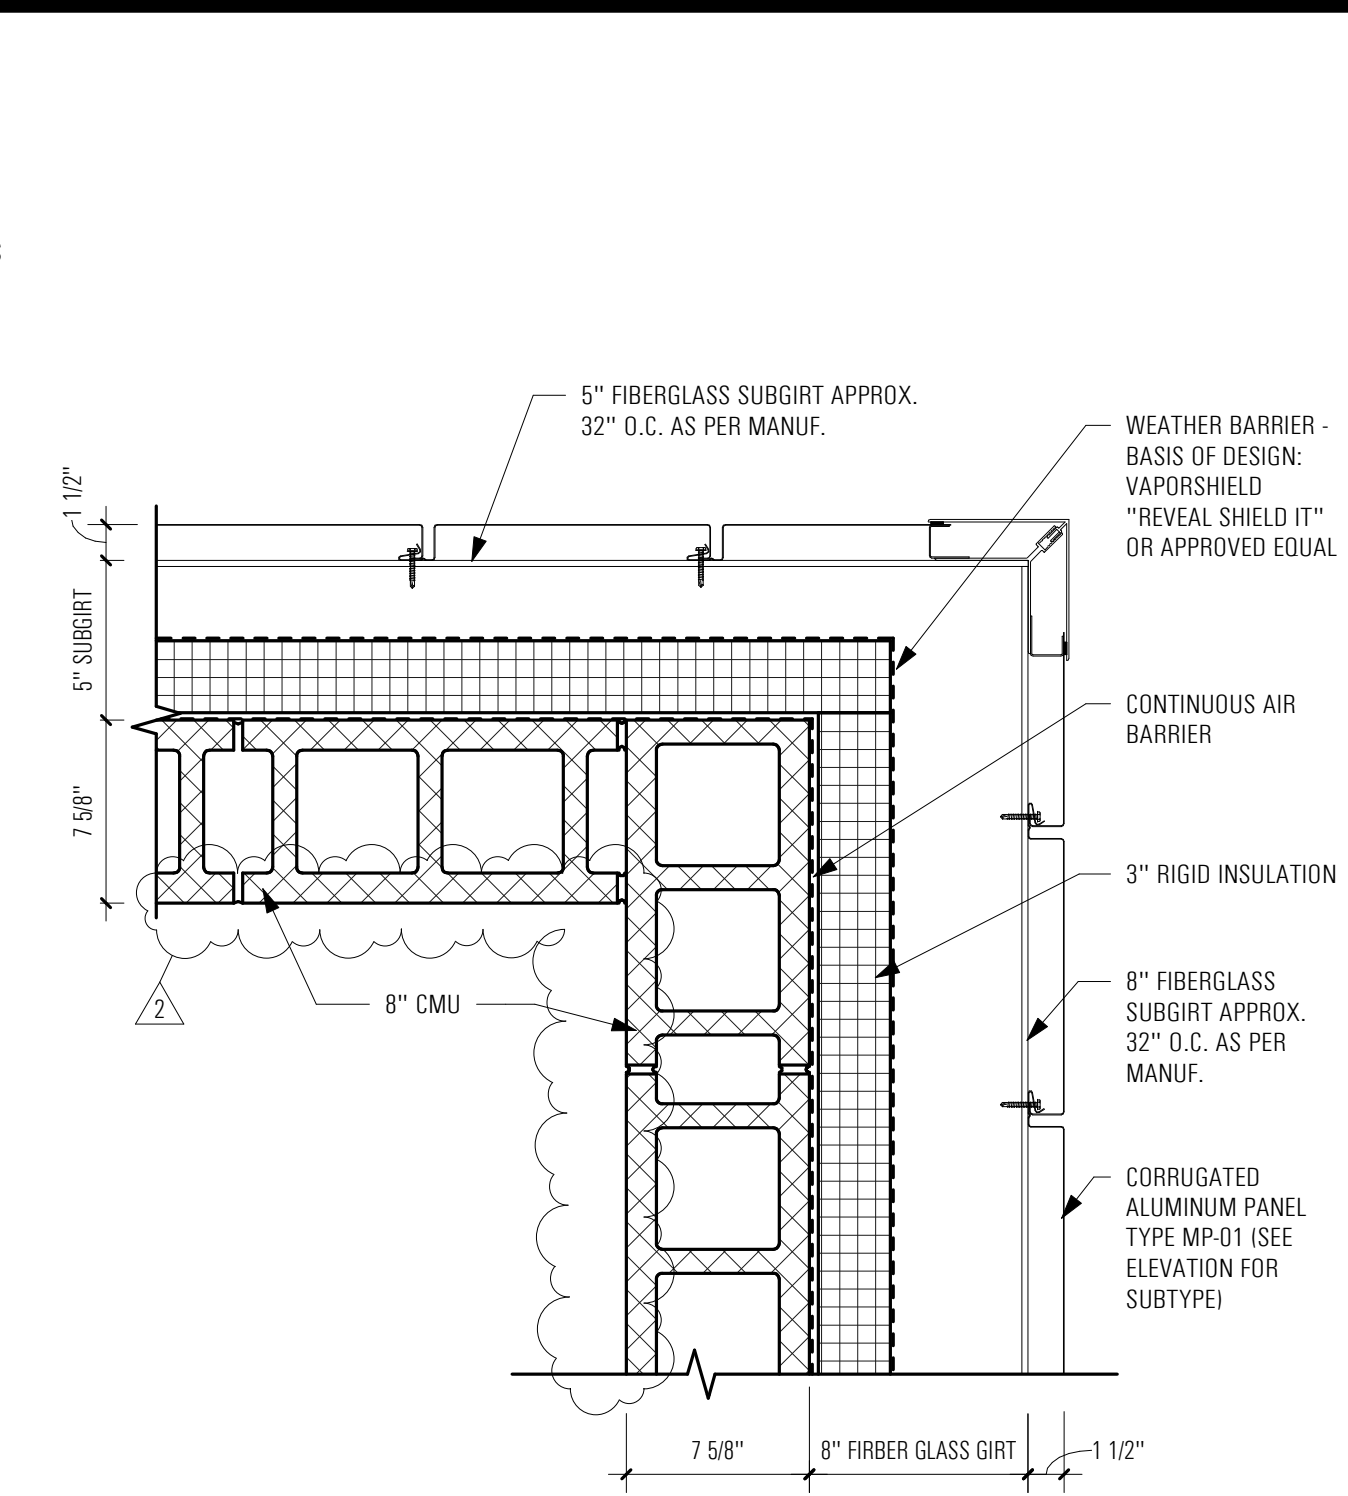

PLAN DETAIL - METAL PANEL DETAIL @ NORTHEAST CORNER - IMAGERY SCALE: 1 1/2" = 1'-0" 3

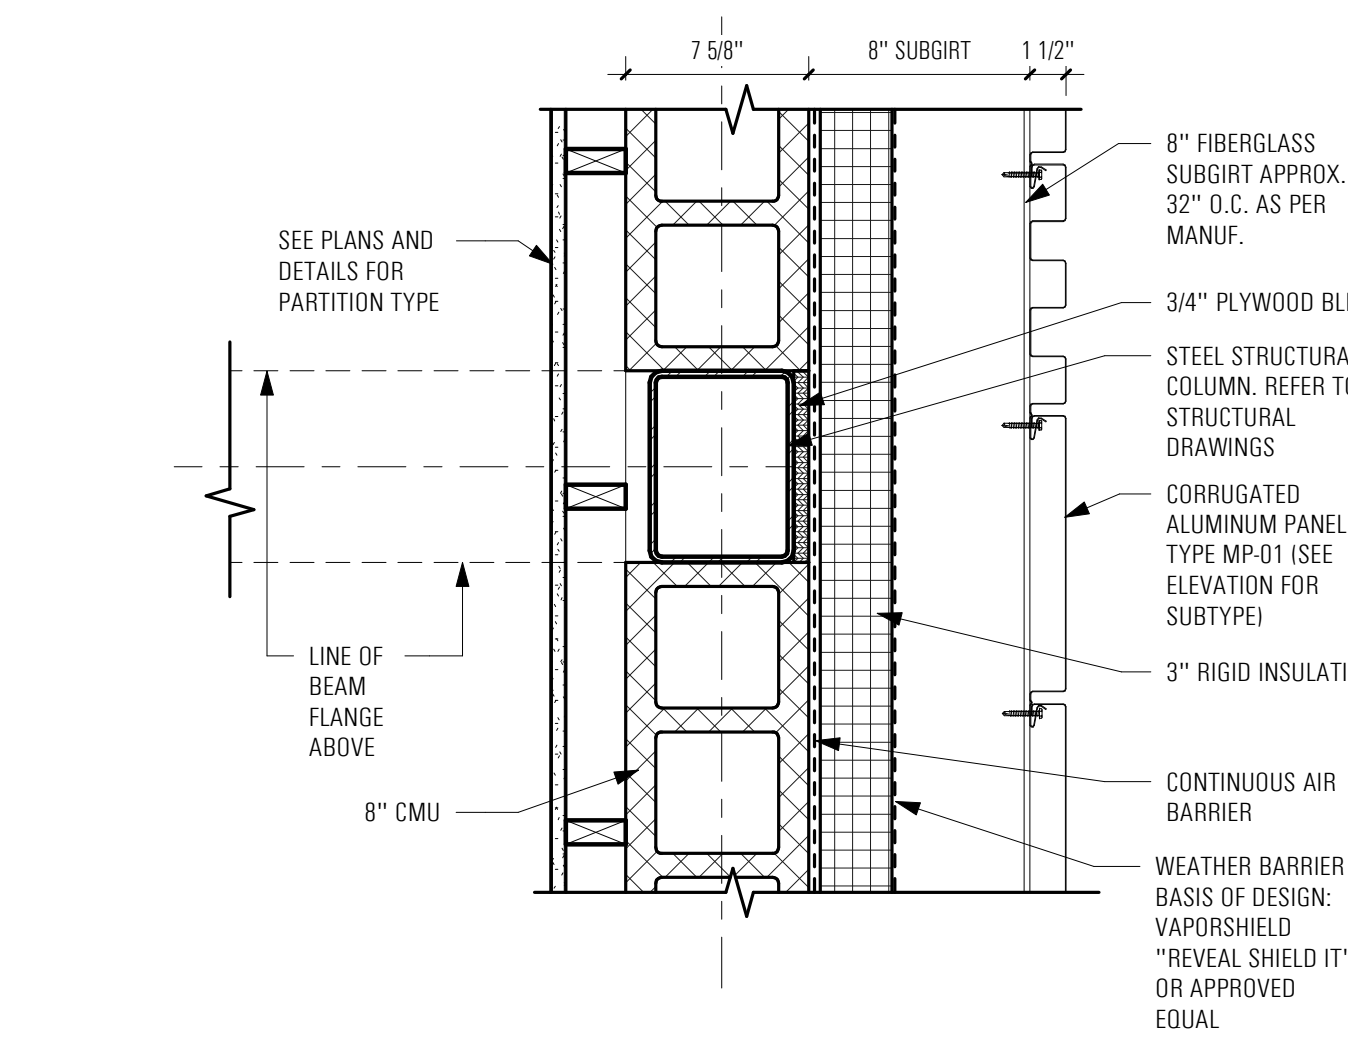

PLAN DETAIL - METAL WALL PANEL @ IMAGERY LOW WALL - EAST SCALE: 1 1/2" = 1'-0" 2

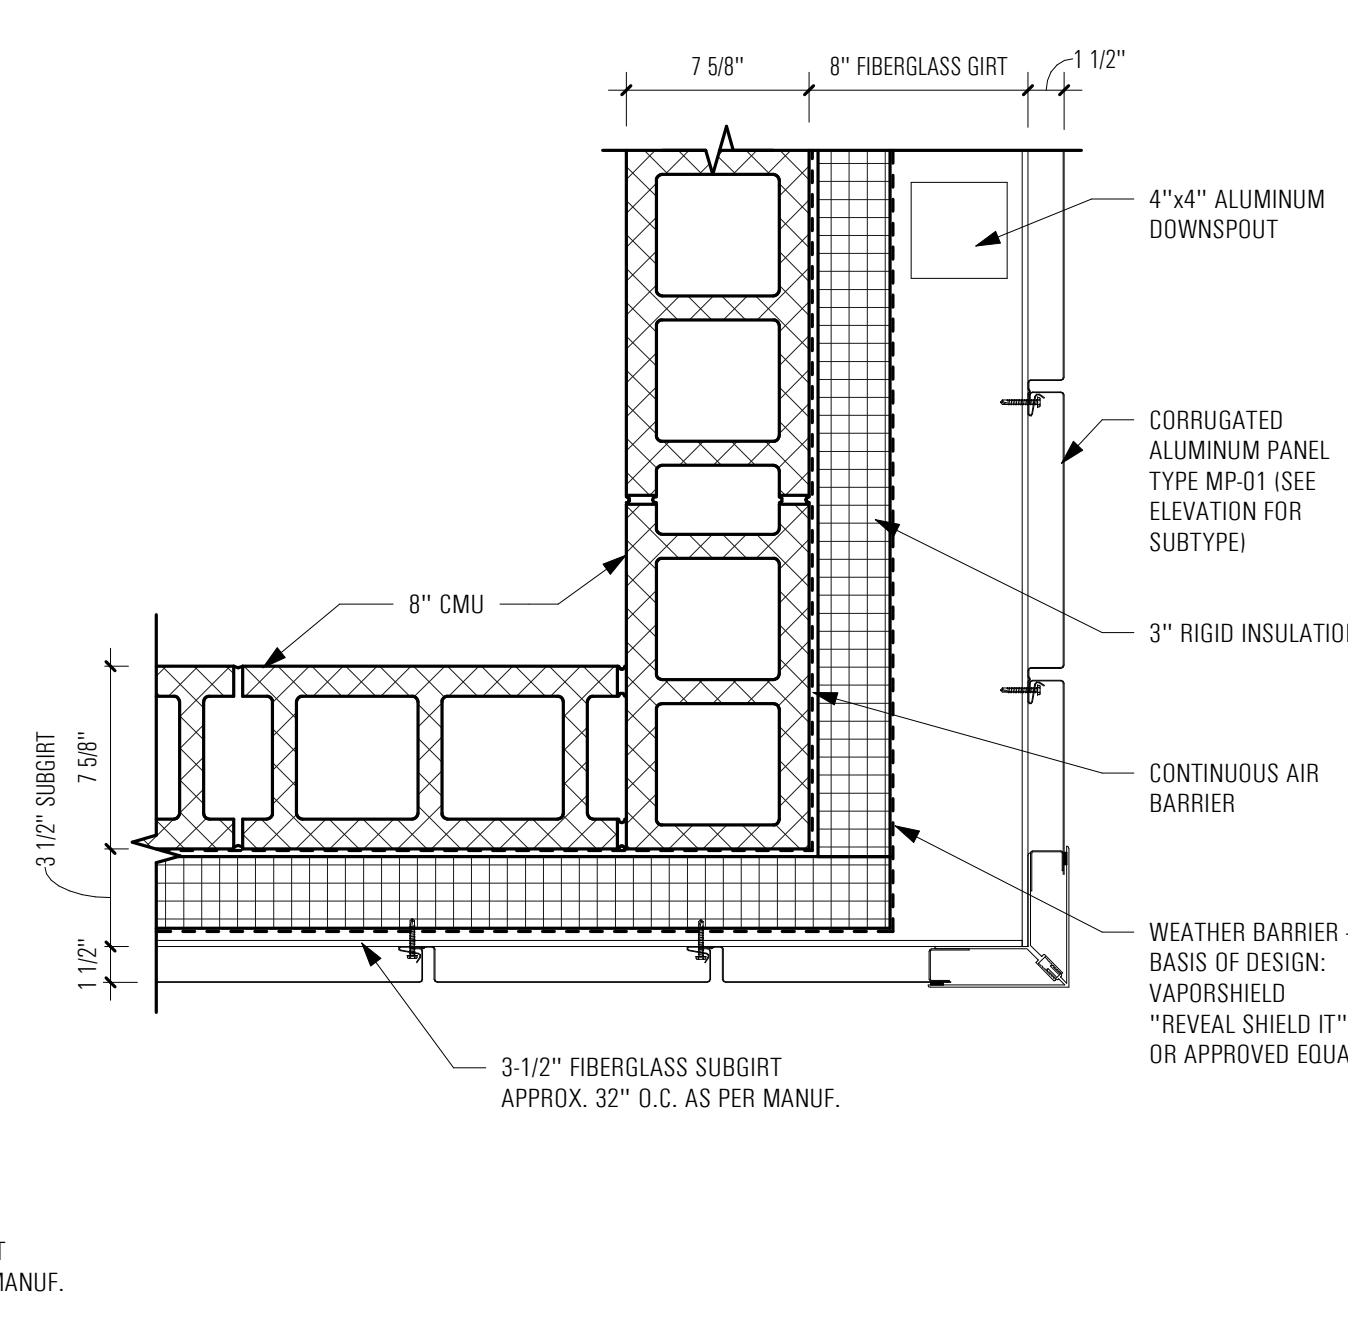

PLAN DETAIL - METAL WALL PANEL @ IMAGERY LOW WALL EXTERNAL CORNER - SOUTHEAST SCALE: 1 1/2" = 1'-0" 1